



GRENGROTTO ISSAQUAH, WA

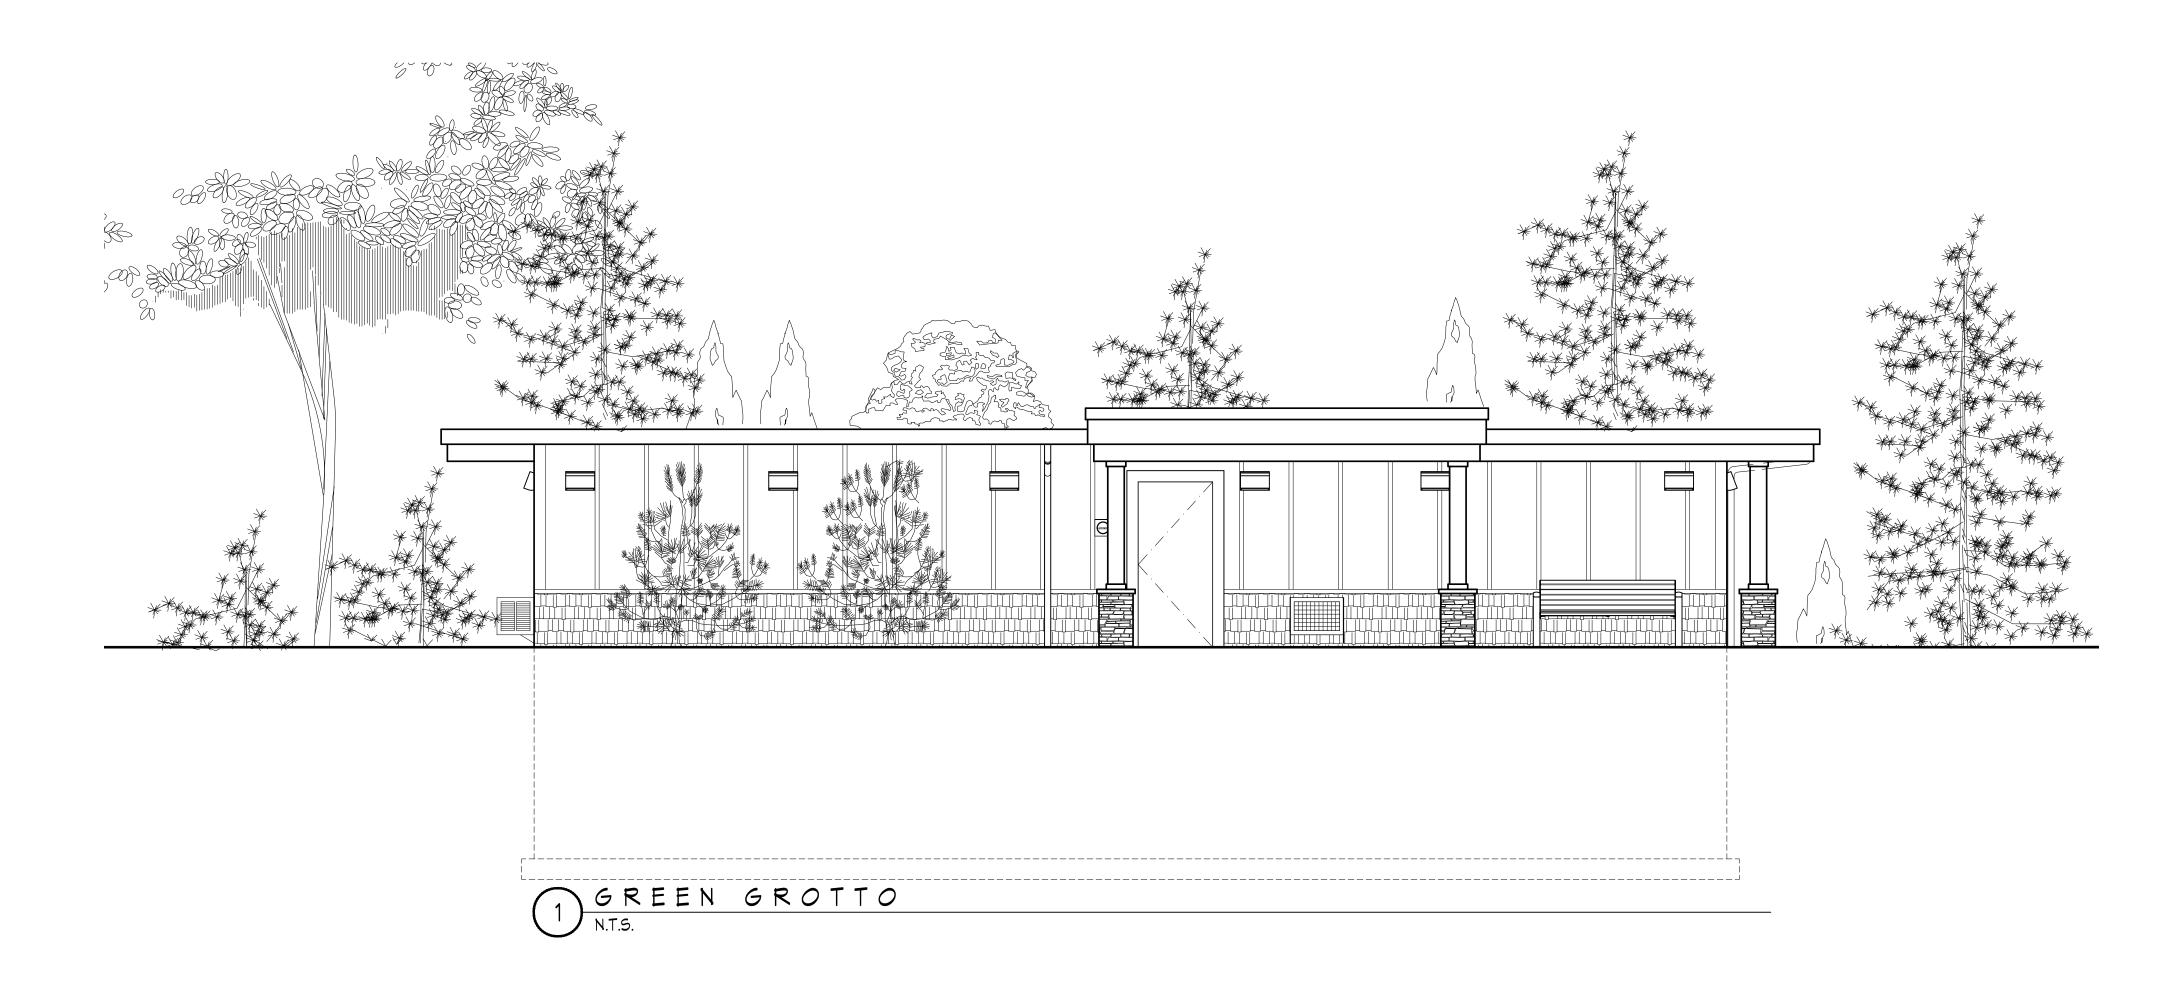

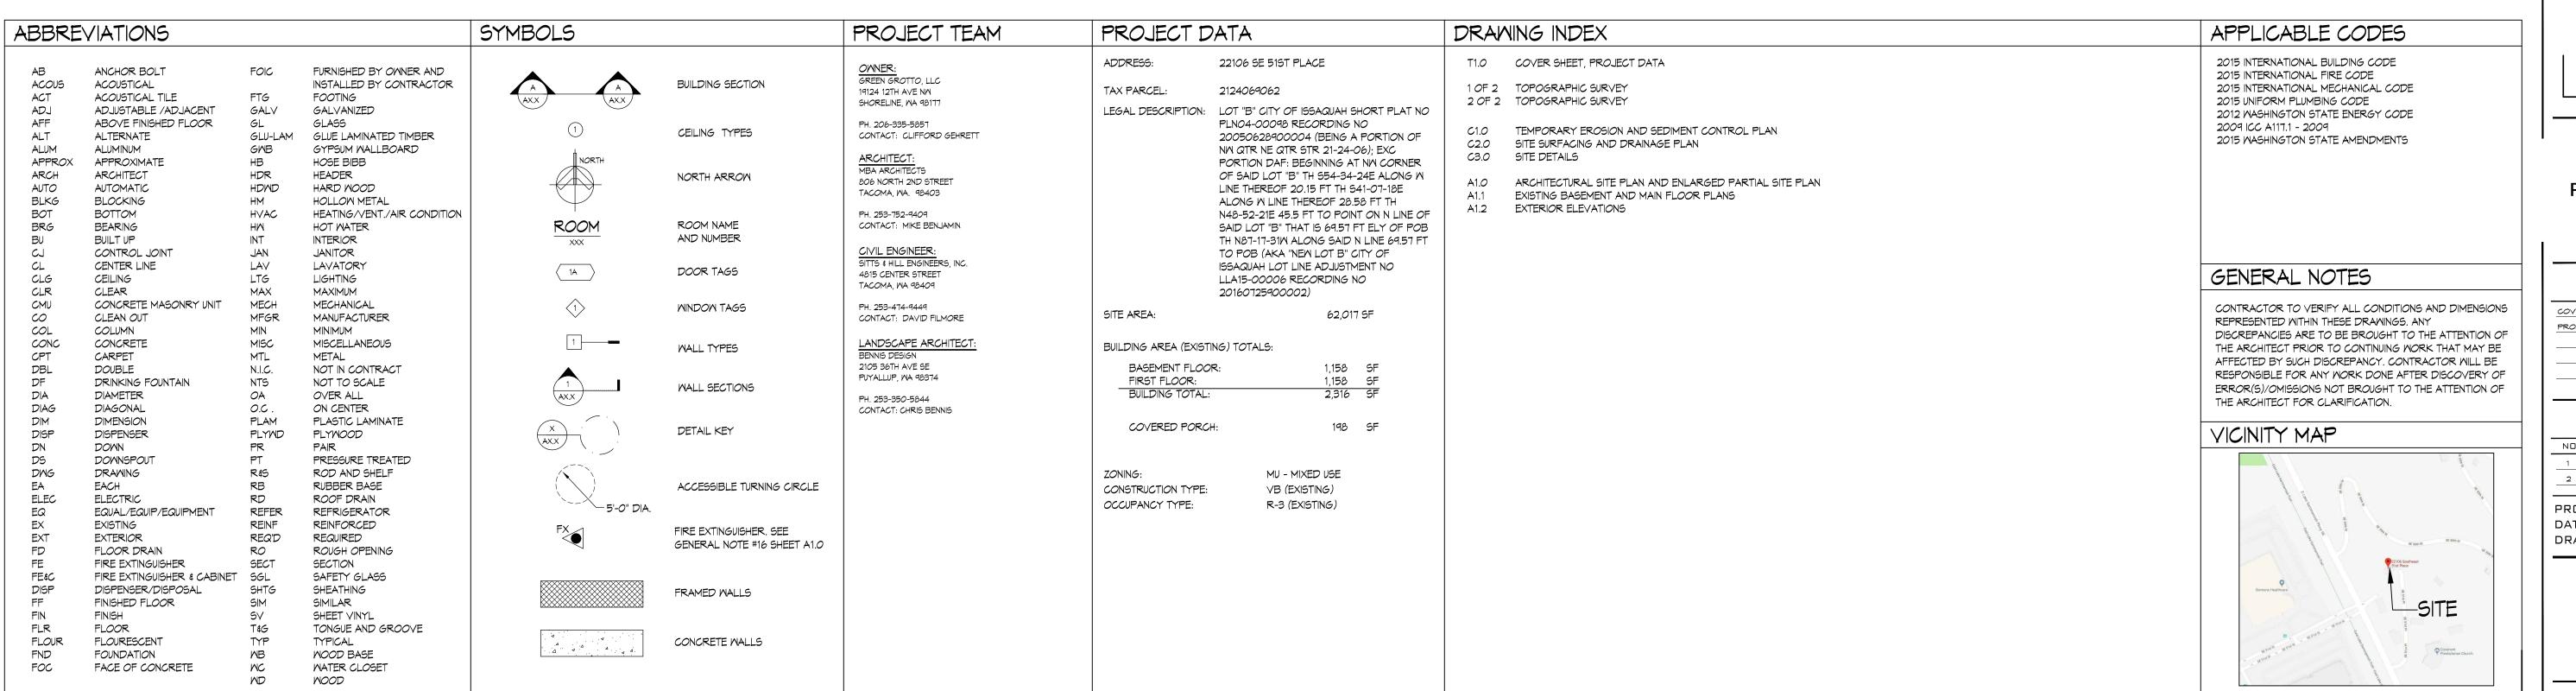

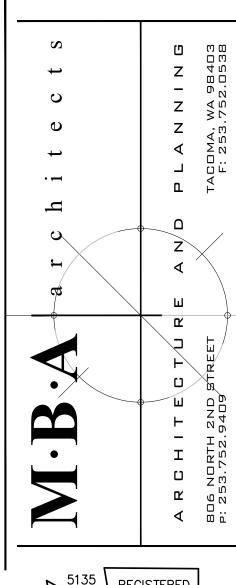

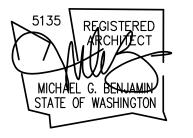

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ASDP17-00005
22106 SE 51ST PLACE
ISSAQUAH, WA 98029

PERMIT SET

CONTENTS

COVERSHEET, CODE DATA
PROJECT TEAM, VICINITY MAP

REVISIONS

NO. DATE ITEM

1 05 JUNE 18 DEPT. COMMENTS
2 28 JUNE 18 DEPT. COMMENTS

PROJECT NO: 18-007
DATE: 28 JUN 18
DRAWN BY: LPA

SHEET NO:

LEGAL DESCRIPTION:
PER CITY OF ISSAQUAH LOT LINE ADJUSTMENT NO. LLA15-00006, KING COUNTY RECORDING NO. 20160725900002

LOT B, CITY OF ISSAQUAH SHORT PLAT NUMBER PLN04-00098, RECORDING NUMBER 200506289000004, IN KING COUNTY, WASHINGTON, EXCEPT THAT PORTION THEREOF DESCRIBED AS FOLLOWS:

BEGINNING AT THE NORTHWEST CORNER OF SAID LOT B; THENCE SOUTH 54°34'24" EAST ALONG THE WEST LINE THEREOF 20.15 FEET;

THENCE SOUTH 41°07'18" EAST ALONG THE WEST LINE THEREOF 28.58 FEET; THENCE NORTH 48'52'21" EAST 45.50 FEET TO A POINT ON THE NORTH LINE OF SAID LOT B THAT IS 69.57 FEET

EASTERLY OF THE POINT OF THE BEGINNING; THENCE NORTH 871731" WEST ALONG SAID NORTH LINE 69.57 FEET TO THE POINT OF BEGINNING.

NOTES AND COMMENTS:

1.) <u>PURPOSE OF SURVEY:</u> THE PURPOSE OF THIS SURVEY WAS TO DEVELOP A 2-FOOT CONTOUR INTERVAL TOPOGRAPHIC MAP OF THE SUBJECT PROPERTY FOR USE AS A PLANNING AND DESIGN BASE BY OTHERS.

2.) HORIZONTAL DATUM: THE OVERALL HORIZONTAL DATUM FOR THIS PROJECT IS NAD 83/2011, WASHINGTON COORDINATE SYSTEM, NORTH ZONE, BASED ON GPS MEASUREMENTS USING THE WASHINGTON STATE REFERENCE NETWORK.

3.) VERTICAL DATUM: THE VERTICAL DATUM FOR THIS SURVEY IS NAVD 88, BASED ON GPS MEASUREMENTS USING THE WASHINGTON STATE REFERENCE NETWORK.

4.) FIELD SURVEY METHODOLOGY: FIELD MEASUREMENTS FOR THIS SURVEY WERE PERFORMED USING A 5-SECOND OR BETTER ELECTRONIC TOTAL STATION.

5.) INSTRUMENT CALIBRATION: ALL MEASURING INSTRUMENTS EMPLOYED IN THIS SURVEY HAVE BEEN MAINTAINED IN ACCORDANCE WITH MANUFACTURER'S SPECIFICATIONS.

6.) THIS MAP GRAPHICALLY REPRESENTS CONDITIONS AND FEATURES EXISTING AT THE TIME OF THIS SURVEY ONLY, WHICH WAS PERFORMED DURING APRIL, 2017 AND FEBRUARY 2018.

7.) THIS SURVEY WAS PREPARED FOR THE <u>EXCLUSIVE</u> USE OF THE CLIENT NAMED HEREON. ITS' USE DOES NOT EXTEND TO ANY UNNAMED PERSON OR PERSONS WITHOUT THE EXPRESS RECERTIFICATION BY THIS SURVEYOR NAMING SUCH PARTY.

8.) FOR YOUR INFORMATION: 0.0833 FEET = 1 INCH ON THE GROUND

9.) KING COUNTY TAX PARCEL NUMBER: 2124069062


10.) PARCEL AREA: 62,018 ± SQ. FT. (1.42 ACRES)

11.) THE UNDERGROUND UTILITIES SHOWN HEREON HAVE BEEN LOCATED FROM THE FIELD SURVEYED LOCATION OF VISIBLE SURFACE UTILITY STRUCTURES SUCH AS MANHOLE LIDS, GRATES, GAS AND WATER VALVE LIDS, ETC. WE MAKE NO GUARANTEE THAT THE UNDERGROUND UTILITIES SHOWN COMPRISE ALL SUCH UTILITIES IN THE AREA, EITHER IN SERVICE OR ABANDONED, NOR THAT THEY ARE IN THE EXACT LOCATION SHOWN.

UTILITY INVERT ELEVATIONS AND PIPE / FLOW LINE DIAMETERS SHOWN HEREON ARE BASED ON OBSERVATIONS FROM THE TOP OF THE UTILITY STRUCTURE AND ARE APPROXIMATE ONLY. FOR SAFETY REASONS NO PHYSICAL ENTRY INTO THE UTILITY STRUCTURE WAS PERFORMED DURING THE COURSE OF THIS SURVEY.

12.) THE PROPERTY AND RIGHT-OF-WAY LINES SHOWN HEREON ARE FOR GENERAL REFERENCE ONLY. THEY HAVE BEEN CALCULATED BASED OFF OF CITY OF ISSAQUAH LOT LINE ADJUSTMENT NO. LLA15-00006, KING COUNTY RECORDING NO. 20160725900002 AND ARE NOT THE RESULT OF AN INDEPENDENT BOUNDARY DETERMINATION BY PLS, INC.


13.) WE HAVE USED GRAPHIC SYMBOLS TO REPRESENT SOME FEATURES ON THIS MAP, SUCH AS UTILITIES, TREES AND FENCES. THE DEFAULT SIZE OF THOSE SYMBOLS MAY NOT REFLECT THE TRUE SIZE OF THE FEATURE THAT WAS MAPPED.

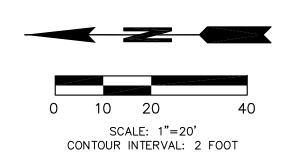

| LEGEND: | |
|--------------|---|
| TPN | TAX PARCEL NUMBER |
| • | FOUND MONUMENT IN CASE |
| | SET PK NAIL |
| | TREE (CONIFEROUS) WITH TRUNK DIAMETER NOTED |
| | TREE (DECIDUOUS) WITH TRUNK DIAMETER NOTED WOOD FENCE |
| | CHAIN LINK FENCE |
| Ъ | MAILBOX |
| д | WOOD SIGN |
| ж | YARD LIGHT |
| \leftarrow | GUY ANCHOR |
| -0- | UTILITY POLE |
| TRANS | TRANSFORMER |
| | UTILITY BOX |
| SL | STREET LIGHT HAND HOLE |
| | TELEPHONE RISER |
| 0 | GAS VALVE |
| Q | FIRE HYDRANT |
| \boxtimes | IRRIGATION CONTROL VALVE |
| ⊞ | WATER METER |
| \bowtie | WATER VALVE |
| | CONCRETE SURFACE |
| | DIRT SURFACE |
| ——ss—— | SANITARY SEWER CONNECTION |
| o SSCO | SANITARY SEWER CLEAN OUT |
| S | SANITARY SEWER MANHOLE (SSMH) |
| | CATCH BASIN (CB) |
| ΙΕ | INVERT ELEVATION |
| PVC | PLASTIC PIPE |

TOPOGRAPHIC SURVEY

NE 1/4 SEC. 21 TOWNSHIP 24 NORTH, RANGE 6 EAST W.M. KING COUNTY, WASHINGTON

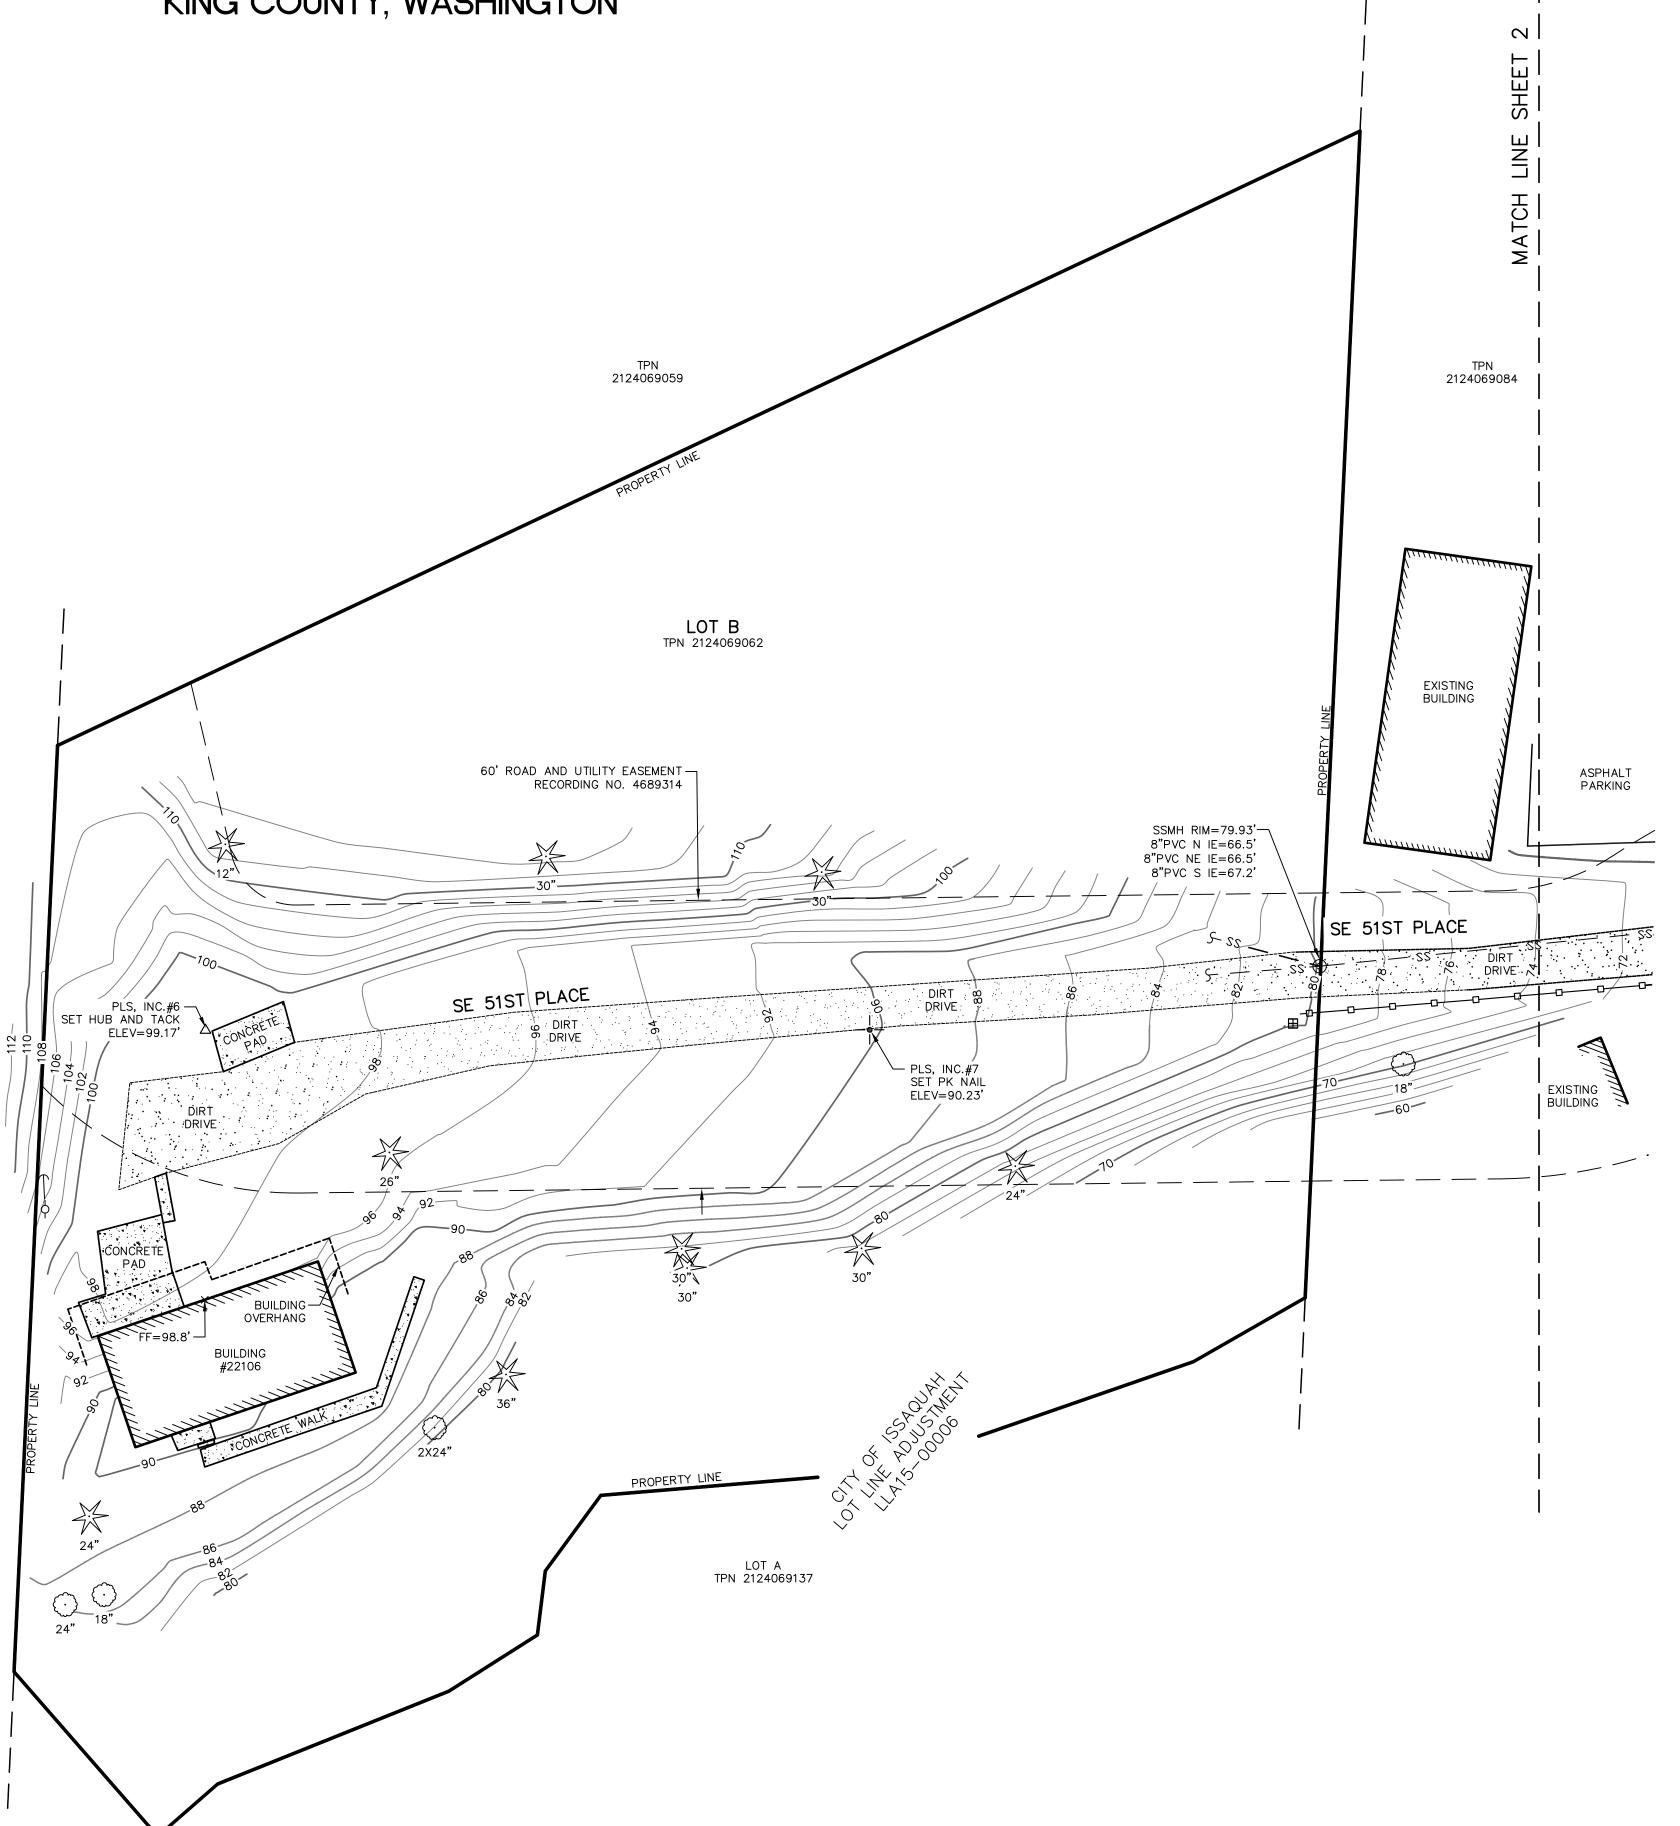

98177 9124




| | BY | ВРМ | | | | | |
|--------------------------|-------------|--------------------------------|---------|------------|--------------|-----|-----|
| REVISIONS | DESCRIPTION | ADDITIONAL TOPOGRAPHIC MAPPING | | | | | |
| | DATE | 3/2/18 | | | | | |
| | NO. | 1 | | | | | |
| SHEET TITLE: TOPOGRAPHIC | SHRVFY | | CLIENT: | | CHICAC NAFER | , | |
| DRAWN BY | • | | | KA | ED P | BY: | |
| | 20' | , | | NTE: PR | 27, | 20 |)17 |
| JOB NO: | | 17 | 05 | 5 | | | |

DRAWING NAME:

17055 TOPO.DWG

TOPOGRAPHIC SURVEY


NE 1/4 SEC. 21 TOWNSHIP 24 NORTH, RANGE 6 EAST W.M. KING COUNTY, WASHINGTON

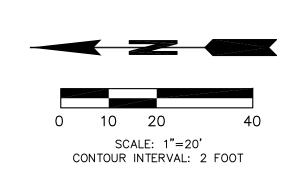

TAX PARCEL NUMBER FOUND MONUMENT IN CASE SET PK NAIL TREE (CONIFEROUS) WITH TRUNK DIAMETER NOTED TREE (DECIDUOUS) WITH TRUNK DIAMÉTER NOTED MAILBOX WOOD SIGN YARD LIGHT UTILITY POLE TRANSFORMER UTILITY BOX STREET LIGHT HAND HOLE TELEPHONE RISER GAS VALVE FIRE HYDRANT IRRIGATION CONTROL VALVE WATER METER WATER VALVE ▶ . CONCRETE SURFACE DIRT SURFACE SANITARY SEWER CONNECTION SANITARY SEWER CLEAN OUT SANITARY SEWER MANHOLE (SSMH)

> CATCH BASIN (CB) INVERT ELEVATION

PLASTIC PIPE

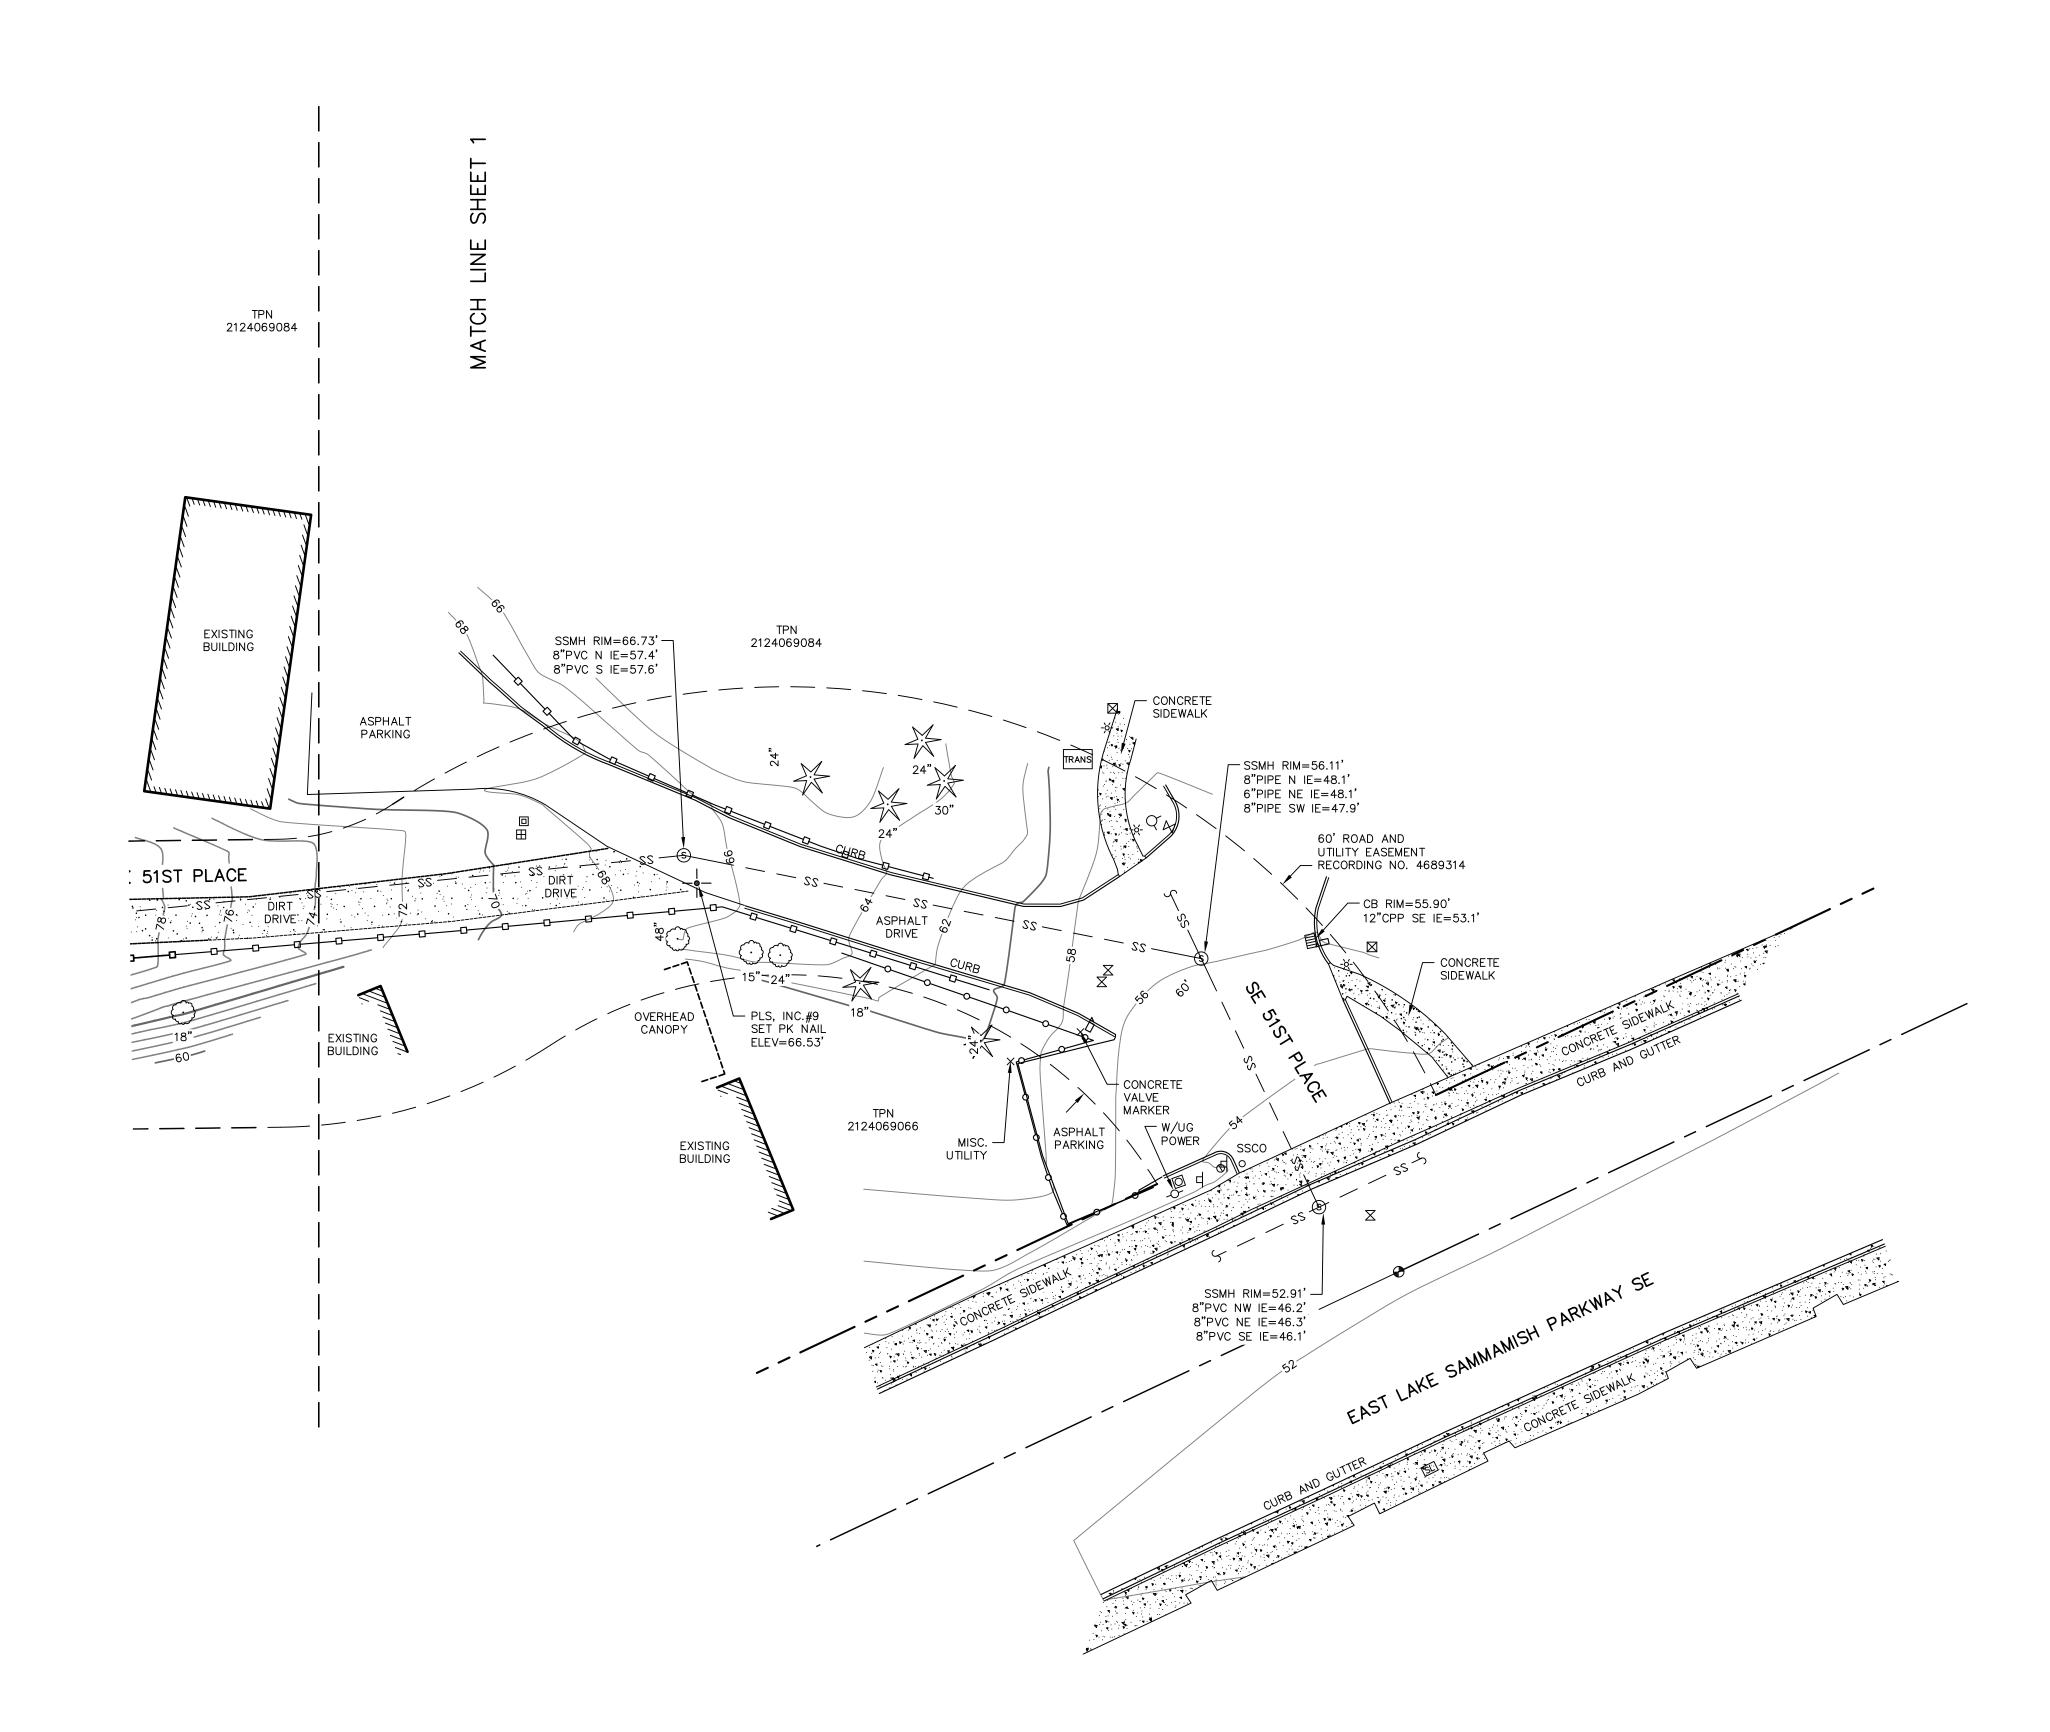



| | BY | ВРМ | | | | | |
|--------------------------|-------------|--------------------------------|---------|------------|----------------|------------------|-----|
| REVISIONS | DESCRIPTION | ADDITIONAL TOPOGRAPHIC MAPPING | | | | | |
| | DATE | 3/2/18 | | | | | |
| | NO. | - | | | | | |
| SHEET TITLE: TOPOGRAPHIC | SIIRVEY | - 1 | CLIENT: | | CII CROTTO IIC | , - - - | |
| DRAWN BY: | | | | KA | ED P | BY: | |
| SCALE: 1"= | 20' | | | nte: PR | 27, | 20 |)17 |
| JOB NO: | 1414 | 17 | 05 | 5 | | | |
| DRAWING N | | : 055 | Т | OP | D.D | WG | |
| SHE | ET | • | 4 | 2 | OF | 2 | |
| | | | | | | | |

LEGEND

PROPOSED FEATURES-

-0 SILT FENCE $\begin{pmatrix} 03 \\ \hline 03.0 \end{pmatrix}$

//// DEMOLITION

---- STOCKPILE AREA $\frac{04}{C3.0}$ — — — — — SAWCUT EXISTING A.C. PAVING

PROJECT LIMITS



CATCH BASIN PROTECTION (02)

ROCK CONSTRUCTION ENTRANCE $\frac{01}{C3.0}$

GENERAL NOTES

- 1. EXISTING SITE FEATURES AND UTILITIES ARE SHOWN BASED UPON A SITE SURVEY PREPARED BY PLS, INC. UNDER JOB NUMBER 17055. NOT ALL SITE FEATURES AND UTILITY SERVICES HAVE BEEN LOCATED OR SHOWN. THE CONTRACTOR SHALL LOCATE, OR HAVE LOCATED, BY TRADITIONAL METHODS, ALL UNDERGROUND UTILITIES PRIOR TO CONSTRUCTION. IF ANY UTILITIES TO REMAIN ARE DAMAGED DURING CONSTRUCTION ACTIVITIES (UTILITIES INCLUDING NOT LIMITED TO SANITARY SEWER, TELEPHONE, DATA, IRRIGATION, BURIED POWER, WATER, SURVEY SYSTEMS, UNDER DRAIN SYSTEMS, GAS). THE CONTRACTOR SHALL BE RESPONSIBLE FOR REPAIR OF DAMAGED UTILITIES AT NO ADDITIONAL COST TO THE OWNER.
- CONTRACTOR SHALL INSTALL CB PROTECTION AT ALL EXISTING CATCH BASINS NOTED. CONTRACTOR SHALL VERIFY CATCH BASIN PROTECTION MEASURES ON A REGULAR BASIS TO ENSURE PROTECTION IS FUNCTIONING.
- 3. CONTRACTOR SHALL TAKE CARE TO PREVENT SEDIMENT FROM ENTERING THE EXISTING AND PROPOSED STORM DRAINAGE SYSTEM.
- 4. CONTRACTOR SHALL REMOVE DIRT AND DEBRIS FROM CATCH BASINS, AND ASSOCIATED CONVEYANCE PIPES (EXISTING AND PROPOSED) WITHIN PROJECT LIMITS (AND AFFECTED DOWNSTREAM SYSTEMS) UPON COMPLETION OF CONSTRUCTION.
- 5. APPROXIMATE LIMITS OF ASPHALT SAWCUT AND DEMOLITION ARE SHOWN. ACTUAL LIMITS SHALL BE BASED ON CONTRACTORS MEANS AND METHODS AND AS NECESSARY TO INSTALL PROPOSED SITE FEATURES AND UTILITIES.
- 6. WHERE CONFLICTS OCCUR BETWEEN THE PLACEMENT OF NEW FEATURES WITH OTHER EXISTING OR PROPOSED FEATURES, THEY SHALL IMMEDIATELY BE BROUGHT TO THE ATTENTION OF THE ENGINEER BY THE CONTRACTOR, AND WILL BE RESOLVED BY THE ENGINEER.
- 7. PROVIDE PLASTIC COVERING AT STOCKPILES (LOCATION TO BE DETERMINED BY CONTRACTOR). CONTRACTOR SHALL VERIFY THE PROPOSED CATCH BASIN PROTECTION MEASURES HAVE BEEN INSTALLED PRIOR TO STOCK PILING MATERIAL.
- 8. UTILITY SERVICE INTERRUPTION TIME SHALL BE COORDINATED WITH OWNER AND LOCAL AGENCIES. PROVIDE TEMPORARY UTILITIES/PUMPING EQUIPMENT AND LABOR TO MAINTAIN REQUIRED SERVICE UNTIL PERMANENT UTILITY INFRASTRUCTURE IS INSTALLED, TESTED AND APPROVED FOR USE.
- 9. PREVENT WIND-BORNE DUST FROM LEAVING THE PROJECT SITE. ON AN AS-NEEDED BASIS KEEP THE WORK AREA MOISTURE CONDITIONED. WATER USED FOR DUST CONTROL SHALL BE MINIMIZED SO THAT IT DOES NOT GENERATE RUNOFF.

CRITICAL AREA NOTE

1. THE NGPE, TOP AND TOE OF SLOPE, SLOPE BUFFER (10'), AND BUILDING SETBACK (15') ARE DEPICTED BASED ON CITY OF ISSAQUAH APPROVALS OF LLA15-00006 AND PLN05-00021.

KEY NOTES


- 1 PROTECT EXISTING FEATURE NOTED
- 2 SAWCUT A.C. PAVING TO SMOOTH, VERTICAL, UNYIELDING EDGE.
- 3 DEMOLISH AND REMOVE EXISTING A.C. PAVING AS NECESSARY TO ACCOMMODATE PROPOSED CONCRETE CURB AND UTILITIES.
- 4 DEMOLISH AND REMOVE EXISTING CONCRETE.
- 5 DEMOLISH EXISTING FEATURE NOTED.
- REMOVE EXISTING FEATURE AND REPLACE IN-KIND
- 7 PROVIDE STREET SWEEPING AT ADJACENT PAVED AREAS AT THE END OF EACH WORK DAY AND AS NECESSARY TO REMOVE SEDIMENT FROM THE SURFACE.
- 8 INSTALL CATCH BASIN PROTECTION UPON INSTALLATION OF PROPOSED CB. SEE DETAIL DETAIL 02/C3.0
- 9 STOCKPILE/EXPOSED SOIL PROTECTION PER DETAIL 04/C3.0 (EXACT LOCATION AND EXTENT T.B.D. BY CONTRACTOR).
- 10 DURING INITIAL EARTH DISTURBING ACTIVITIES, THE CONSTRUCTION STORMWATER DISCHARGE MONITORING POINT IS AT THE EXISTING POINT OF DISCHARGE FROM THE SITE, AT THE EXISTING DRIVEWAY ENTRY. AFTER PAVING AND INSTALLATION OF PROPOSED CATCH BASINS, SEE KEYNOTE 11.
- 11 MONITORING POINT IS AT THE PROPOSED OUTFALL UPON COMPLETION OF PAVING AND UPON SUBSTANTIAL COMPLETION OF PROJECT.
- 12 SEE LANDSCAPE PLANS FOR TREE PROTECTION, AS REQUIRED.
- 13 SAWCUT AND REMOVAL OF A.C. PAVING WITHIN RIGHT-OF-WAY PER CITY OF ISSAQUAH STANDARD DETAIL T-48.
- 14 REMOVE AND REPLACE CONCRETE WALK, IN-KIND TO NEAREST EXISTING CONSTRUCTION JOINT.




GROT 2TH AVE

GREEN 19124 12 SHOREL

17372

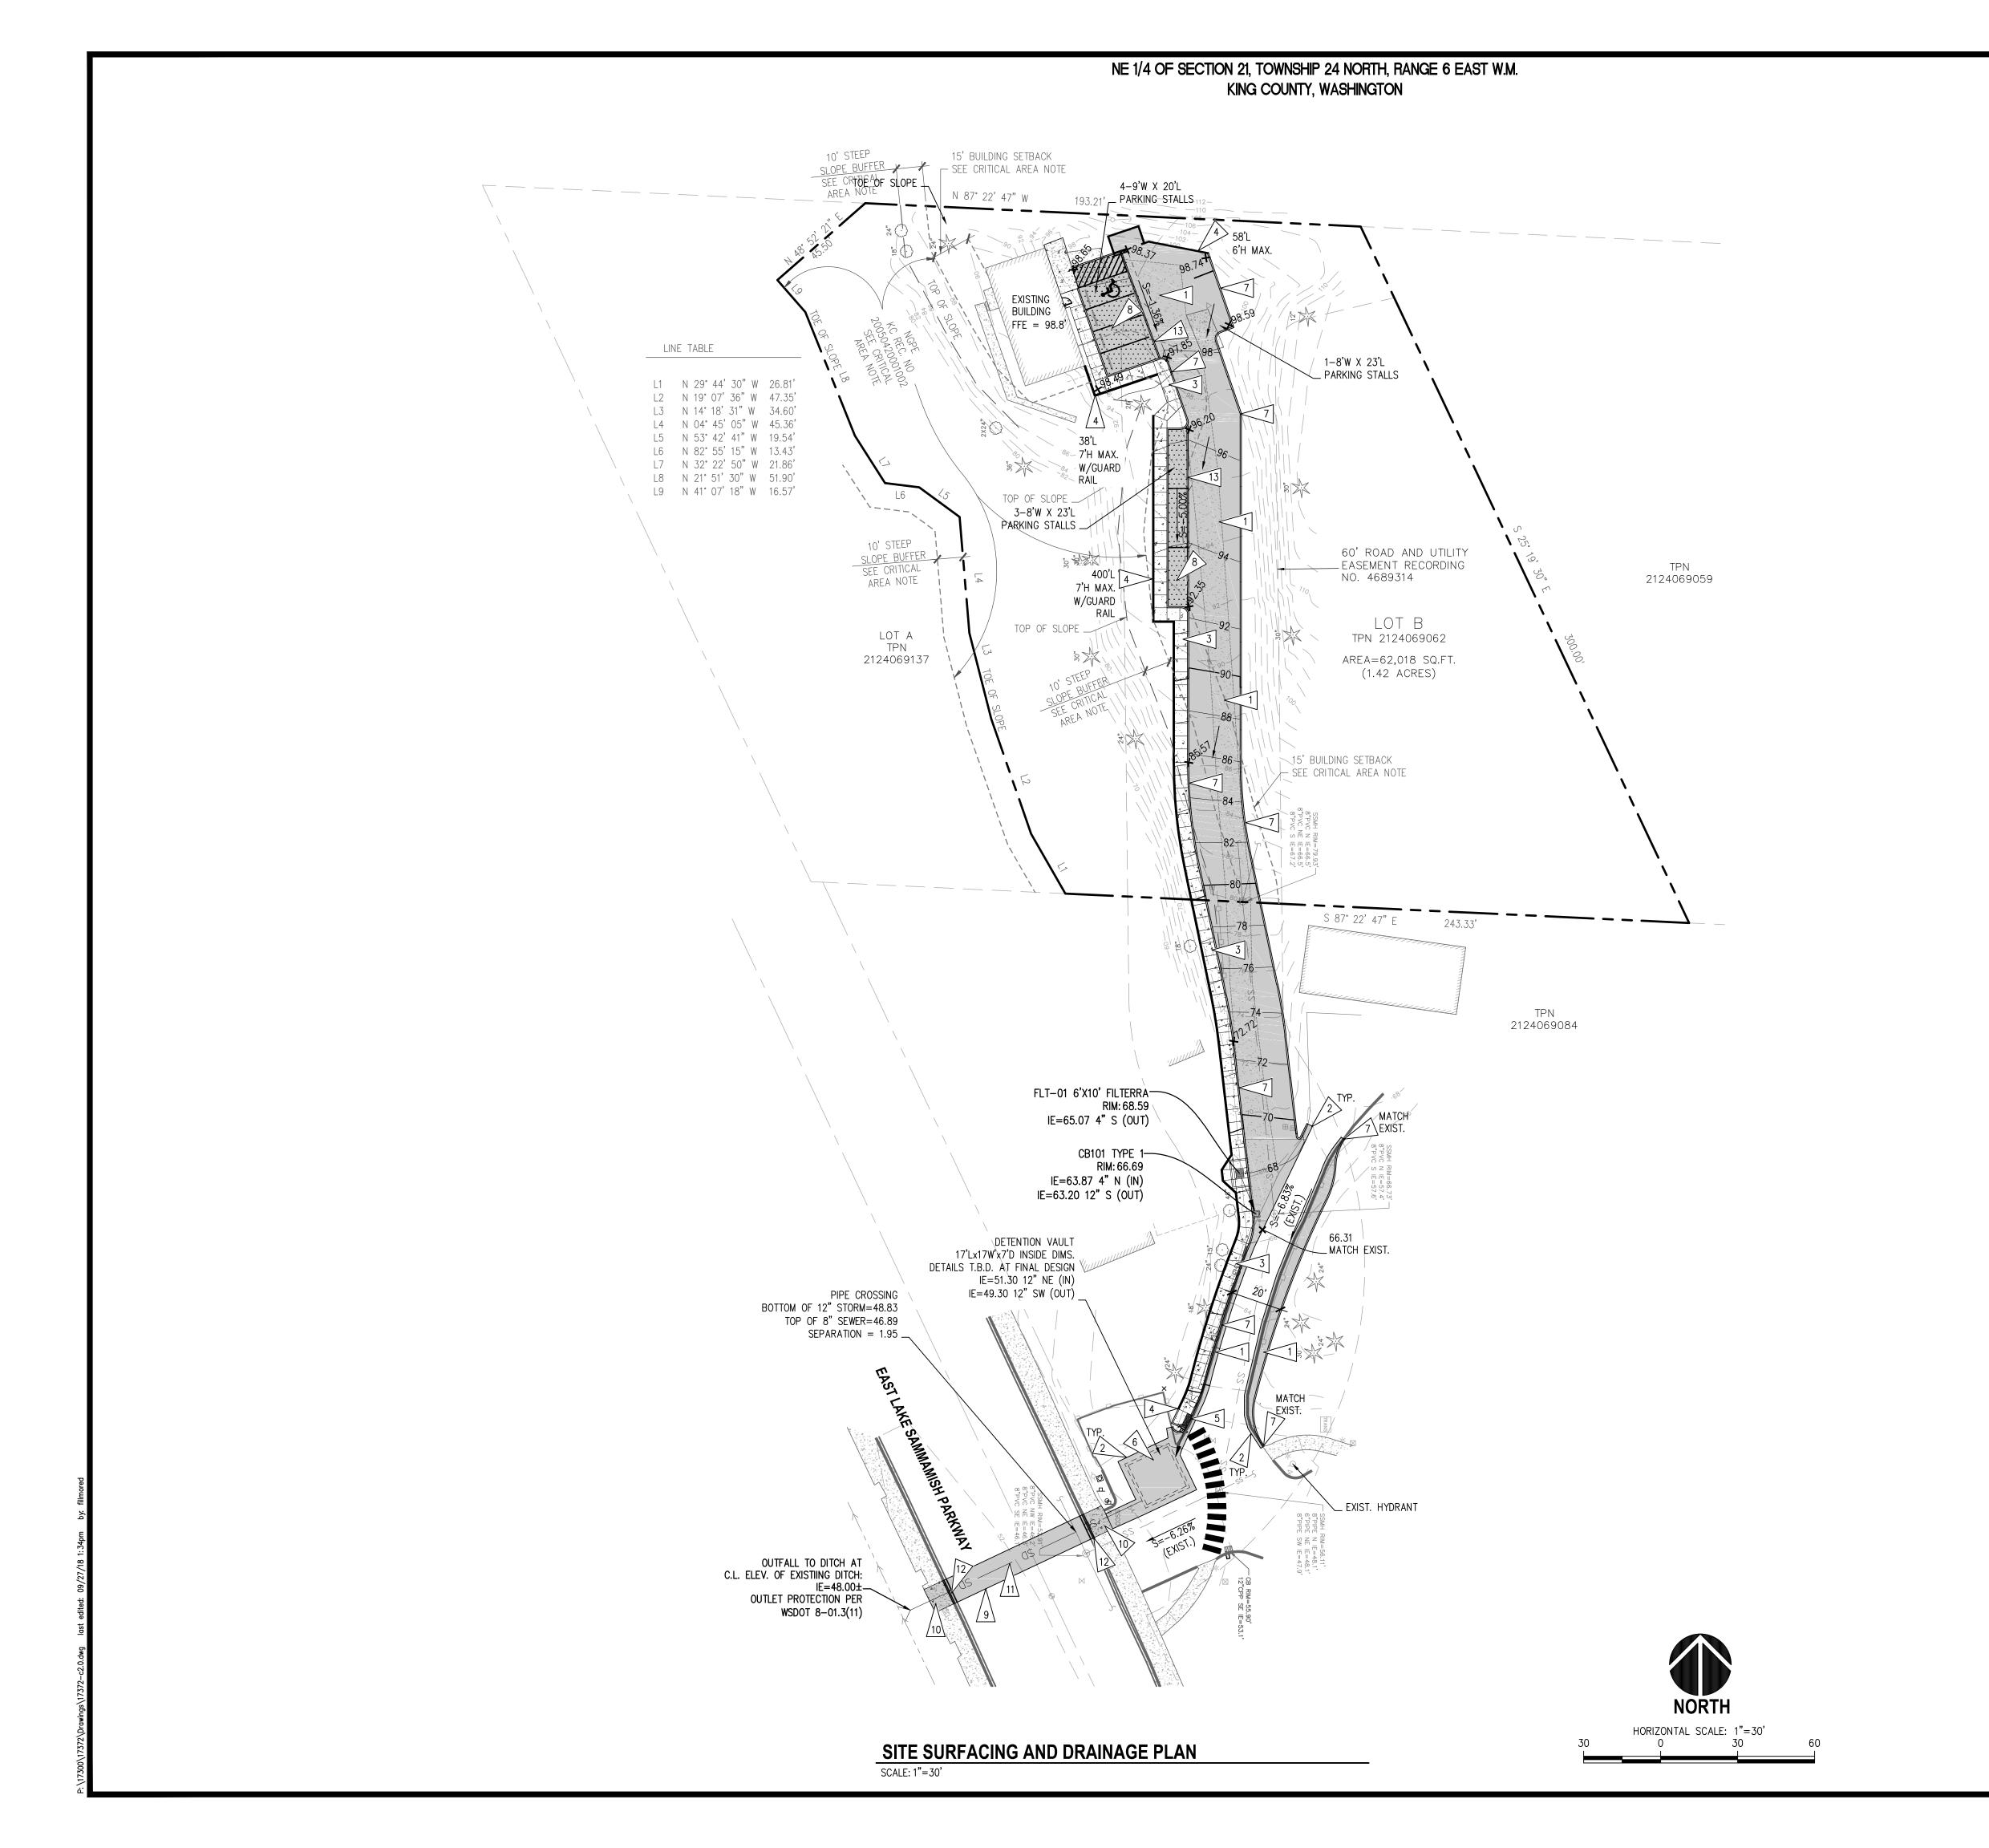

LEGEND

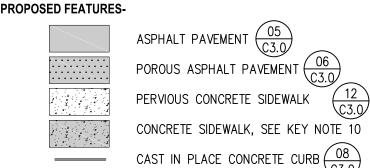

FLOW ARROW

ADA PARKING SYMBOL (07)

GENERAL NOTES

- 1. EXISTING WATER AND SEWER SERVICES TO THE EXISTING STRUCTURE SHALL BE MAINTAINED THROUGHOUT-AND UPON COMPLETION OF-THE PROPOSED CONSTRUCTION.
- 2. PROVIDE A FULL NFPA 13 FIRE SPRINKLER AND FIRE ALARM SYSTEM. THE FIRE PROTECTION SYSTEM SHALL BE DESIGNED, FABRICATED, AND INSTALLED IN ACCORDANCE WITH THE MOST UP-TO-DATE VERSION OF NFPA 13 TOGETHER WITH LOCAL AMENDMENTS.
- 3. ALL SOIL AREAS DISTURBED DURING CONSTRUCTION, AND NOT COVERED BY BUILDING OR PAVEMENT SHALL BE SUBJECT TO "SOIL AMENDMENT AND DEPTH" REQUIREMENTS PER DOE BMP T5.13.
- 4. SEE LANDSCAPE PLANS FOR SITE LANDSCAPING AND IRRIGATION.
- 5. ADJUST OR SET THE FRAMES OF EXISTING AND PROPOSED UTILITY GRATES AND COVERS TO MATCH THE CROSS SLOPE OF THE PROPOSED FINISH GRADE.
- 6. GRADE ACROSS FILTERRA INLET TO MAX 5% LONGITUDINAL SLOPE.

CRITICAL AREA NOTE

1. THE NGPE, TOP AND TOE OF SLOPE, SLOPE BUFFER (10'), AND BUILDING SETBACK (15') ARE DEPICTED BASED ON PLANS PREVIOUSLY APPROVED BY THE CITY OF ISSAQUAH UNDER LLA15-00006 AND PLN05-00021.

KEY NOTES

- 1 ASPHALT PAVEMENT, SEE DETAIL 05/C3.0
- 2 ASPHALT PAVEMENT JOINT, SEE DETAIL 09/C3.0
- PERVIOUS CONCRETE SIDEWALK, SEE DETAIL 12/C3.0
- 4 CMU BLOCK RETAINING WALL, LENGTH AND MAX HEIGHT PER PLAN
- 5 ADA RAMP PER WSDOT STANDARDS
- 6 SEE DETAIL 13/C3.0 FOR VAULT AND RISER REQUIREMENTS.
- 7 CAST-IN-PLACE CONCRETE CURB, SEE DETAIL 08/C3.0
- 8 POROUS ASPHALT PAVEMENT, SEE DETAIL 06/C3.0
- 9 ASPHALT PAVEMENT PATCHING IN RIGHT-OF-WAY PER CITY OF ISSAQUAH STANDARD DETAIL T-48. REMOVE AND REPLACE CONCRETE SIDEWALK, IN-KIND TO NEAREST EXISTING CONSTRUCTION JOINT.
- 11 TRENCHING IN RIGHT-OF-WAY PER CITY OF ISSAQUAH STANDARD
- DETAIL T-50. 12 REPLACE CURB AND GUTTER IN KIND. SEE CITY OF ISSAQUAH STANDARD DETAIL T-38.
- DEPRESSED CONCRETE CURB PER DETAIL 14/C3.0

PROPOSED FEATURES-

CAST IN PLACE CONCRETE CURB

GREEN GROTTO, I 19124 12TH AVENUE S SHORELINE, WA 9817'

ACE

GREEN GROTTO
22106 SE 51ST PL/
ISSAQUAH, WASHINGTON

A SHET THE

S SITE SURFACING AN

DRAINAGE PLAN

C2.0

17372



2"x2"x14 GA. WELDED -

WIRE FABRIC OR EQUAL

TYPICAL CROSS-SECTION

ELEVATION

1. PLACE 1' OF 3/4" - 1-1/2" WASHED

FENCE TO CREATE A BEVEL SHAPE.

FABRIC SHALL COVER BOTTOM OF 6"x6" TRENCH AND EXTEND BEYOND THE LIMITS

OF THE GRAVEL IN ORDER TO MAINTAIN

SHOWN IN TYPICAL CROSS-SECTION.

AN EXCESS OVERLAP OF 2" MINIMUM AS

ROCK OR PEA-GRAVEL ON BOTH SIDES OF

CONSTRUCTION ENTRANCE NOTES

- MATERIAL SHALL BE 4-INCH TO 8-INCH QUARRY SPALLS AND MAY BE TOP-DRESSED WITH 1-INCH TO 3-INCH ROCK. (STATE STANDARD SPECIFICATIONS, SECTION 8-15.)
- THE ROCK PAD SHALL BE AT LEAST 12 INCHES THICK AND 100 FEET LONG WIDTH SHALL BE THE FULL WIDTH OF THE VEHICLE INGRESS AND EGRESS AREA.
- ADDITIONAL ROCK SHALL BE ADDED PERIODICALLY TO MAINTAIN PROPER FUNCTION OF THE PAD.
- 4. IF THE PAD DOES NOT ADEQUATELY REMOVE THE MUD FROM THE VEHICLE WHEELS, THE WHEELS SHALL BE HOSED OFF BEFORE THE VEHICLE ENTERS A PAVED STREET. THE WASHING SHALL BE DONE ON AN AREA COVERED WITH CRUSHED ROCK AND WASH WATER SHALL DRAIN TO A SEDIMENT RETENTION FACILITY OR THROUGH A SILT FENCE.

ROCK CONSTRUCTION ENTRANCE

STAPLE OR WIRE RINGS-

FILTER FABRIC MATERIAL

MIRAFI 100x OR EQUAL

(TYPICAL)

AT 4' O.C.

2"x4" DOUG. FIR -

6"x6" TRENCH -

GA. W.W.F.

FILTER FABRIC—


2"x4" DOUG. FIR


OR EQUAL ——


MATERIAL 2"x2"x14

SILT FENCE NOTES

- 1. FILTER FABRIC SHALL BE PURCHASED IN A CONTINUOUS ROLL AND CUT TO THE LENGTH OF THE BARRIER TO AVOID USE OF JOINTS. WHEN JOINTS ARE NECESSARY, FILTER CLOTH SHALL BE SPLICED TOGETHER ONLY AT A SUPPORT POST WITH A MINIMUM 6 INCH OVERLAP, AND SECURELY FASTENED AT BOTH ENDS TO POSTS.
- 2. POSTS SHALL BE SPACED A MAXIMUM OF 6 FEET APART AND DRIVEN SECURELY INTO THE GROUND (MINIMUM OF 30 INCHES).
- 3. A TRENCH SHALL BE EXCAVATED APPROXIMATELY 8 INCHES WIDE AND 12 INCHES DEEP ALONG THE LINE OF POSTS AND UPSLOPE FROM THE BARRIER. THIS TRENCH SHALL BE BACKFILLED WITH WASHED GRAVEL.
- WHEN STANDARD STRENGTH FILTER FABRIC IS USED, A WIRE MESH SUPPORT FENCE SHALL BE FASTENED SECURELY TO THE UPSLOPE SIDE OF THE POSTS USING HEAVY-DUTY WIRE STAPLES AT LEAST 1 INCH LONG, TIE WIRES OR HOG RINGS. THE WIRE SHALL EXTEND INTO THE TRENCH A MINIMUM OF 4 INCHES AND SHALL NOT EXTEND MORE THAN 24 INCHES ABOVE THE ORIGINAL GROUND SURFACE.
- THE STANDARD STRENGTH FILTER FABRIC SHALL BE STAPLED OR WIRED TO THE FENCE, AND 20 INCHES OF THE FABRIC SHALL BE EXTENDED INTO THE TRENCH. THE FABRIC SHALL NOT EXTEND MORE THAN 24 INCHES ABOVE THE ORIGINAL GROUND SURFACE. FILTER FABRIC SHALL NOT BE STAPLED TO EXISTING TREES.
- WHEN EXTRA-STRENGTH FILTER FABRIC AND CLOSER POST SPACING IS USED, THE WIRE MESH SUPPORT FENCE MAY BE ELIMINATED. IN SUCH CASE, THE FILTER FABRIC IS STAPLED OR WIRED DIRECTLY TO THE POSTS WITH ALL OTHER
- FILTER FABRIC FENCES SHALL BE INSPECTED IMMEDIATELY AFTER EACH RAINFALL AND AT LEAST DAILY DURING
- 9. SILT FENCES WILL BE INSTALLED PARALLEL TO ANY SLOPE CONTOURS.

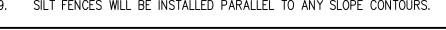


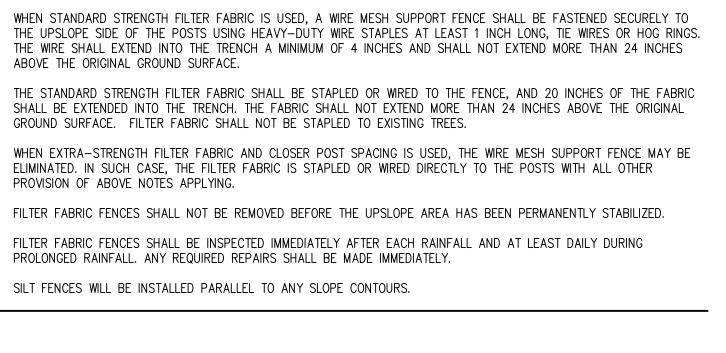

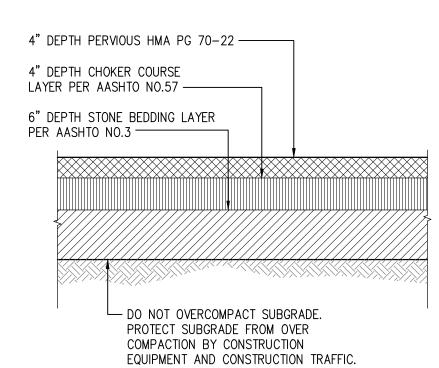




POROUS ASPHALT PAVEMENT SECTION

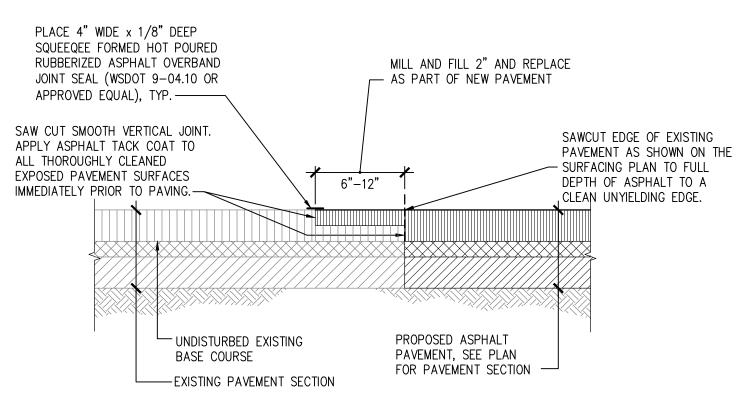



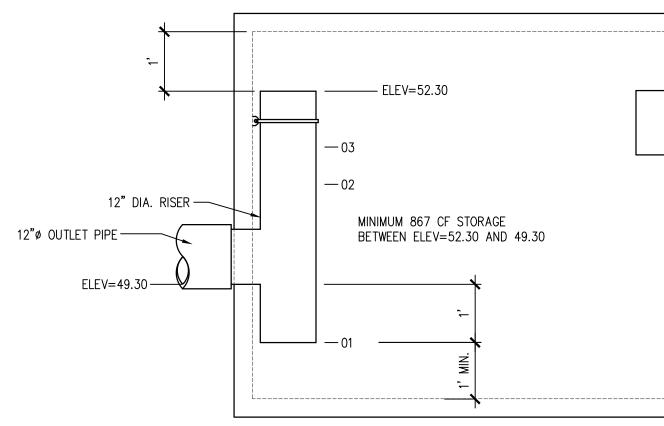

WHITE BORDER

4" TYP.


R=5 3/4"

CATCH BASIN GRATE PLACED OVER INSTALL INSERT

OVERFLOW BYPASS -

SEDIMENT ACCUMULATION -

CB PROTECTION DETAIL

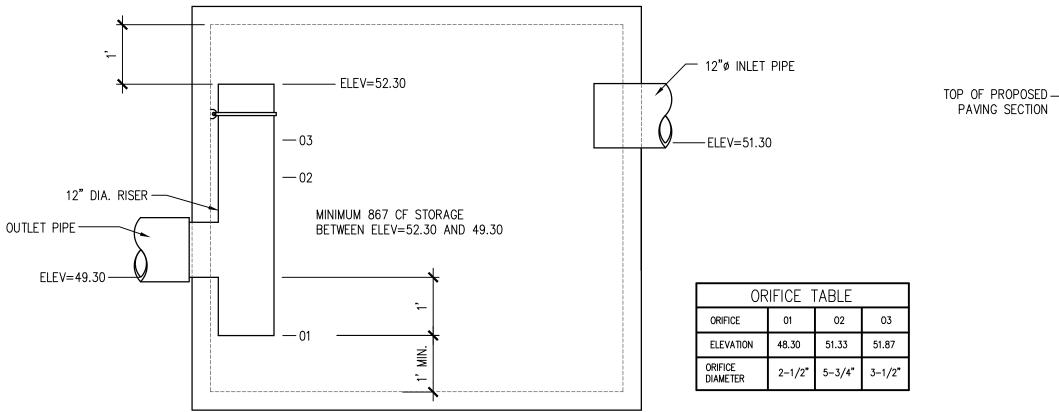

1'-8" 5" 11" 4"

PAINT SOLID — 3" GOF STALL PAINT SOLID BLUE

BACKGROUND

6'-6 3/4"


WHITE, TYP

STORMWATER DETENTION VAULT AND RISER

ASTM D-1557

CATCH BASIN PROTECTION NOTES

- 1. CATCH BASIN INSERTS SHALL BE PROVIDED IN THE CATCH BASINS NOTED ON THE
- 2. AT ALL PROPOSED CATCH BASINS, CATCH BASIN PROTECTION SHALL BE INSTALLED IMMEDIATELY UPON CATCH BASIN INSTALLATION AND SHALL REMAIN UNTIL FINAL SITE STABILIZATION.
- 3. CATCH BASIN INSERT SHALL BE BOWHEAD STREAMGUARD CATCH BASIN INSERT #3003, ADVANCED ENVIRONMENTAL SOLUTIONS DRAINGUARD CATCH BASIN FILTER INSERT #11091U, OR APPROVED EQUAL.
- 4. CATCH BASIN INSERTS SHALL BE INSTALLED IN ACCORDANCE WITH MANUFACTURER'S RECOMMENDATIONS.
- 5. CATCH BASIN INSERTS WILL BE REMOVED FOLLOWING COMPLETION OF CONSTRUCTION AND STABILIZATION OF ALL CLEARED AREAS.

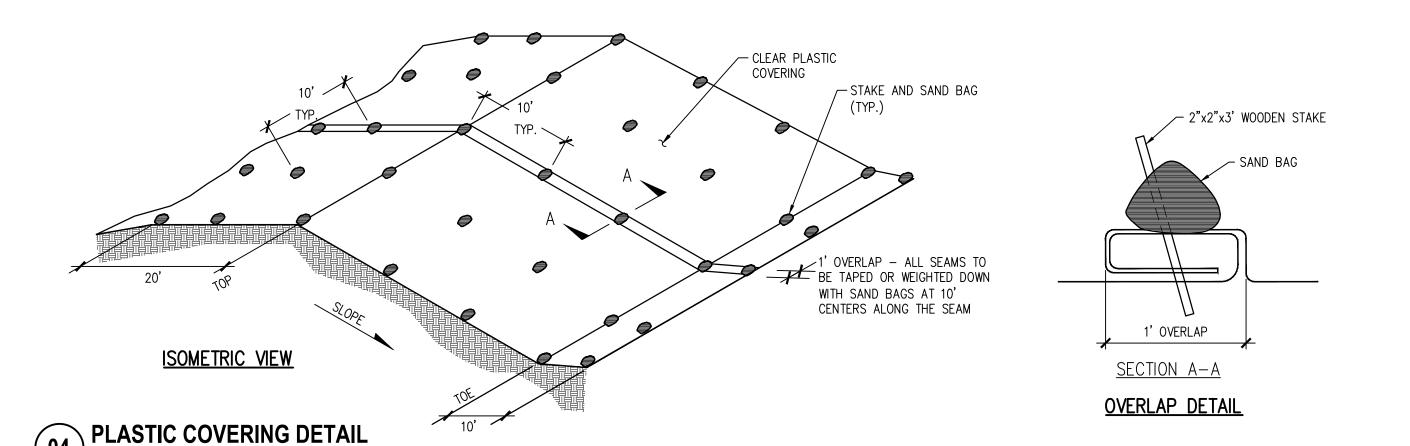


RETRIEVAL STRAP (INSTALL

CATCH BASIN INSERT


ADAPTER SKIRT

MANUFACTURED CATCH BASIN INSERT

THROUGH GRATE)

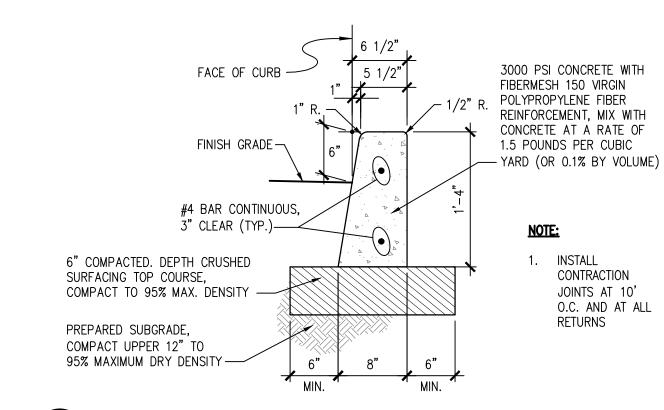



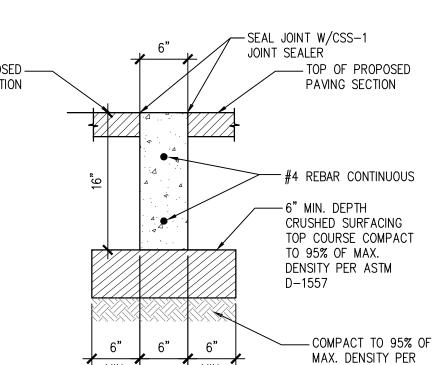

DEPRESSED CONCRETE CURB SECTION

GREEN GROTTO
22106 SE 51ST PLA
SSAQUAH, WASHINGTON
S DETAILS

O

GROT

GREEN19124 12
SHOREL

17372

3" COMPACTED DEPTH CLASS 1/2" HMA PG 64-22 (1 LIFT), COMPACT TO 92% OF RICE VALUE -4" COMPACTED DEPTH CRUSHED SURFACING TOP COURSE, COMPACT TO 95% MAXIMUM DENSITY ——— PREPARED SUBGRADE, COMPACT UPPER 12" TO 95% MAXIMUM DENSITY —

SCALE: N.T.S.

PAVEMENT JOINT SECTION

4" DEPTH PERVIOUS CONCRETE ————

☐ DO NOT OVERCOMPACT SUBGRADE. PROTECT SUBGRADE FROM OVER

COMPACTION BY CONSTRUCTION

EQUIPMENT AND CONSTRUCTION TRAFFIC.

2" DEPTH CHOKER COURSE LAYER


4" DEPTH STONE BEDDING LAYER

PER AASHTO NO. 57 ----


PER AASHTO NO.3 ---

SCALE: N.T.S

ADA PARKING SYMBOL

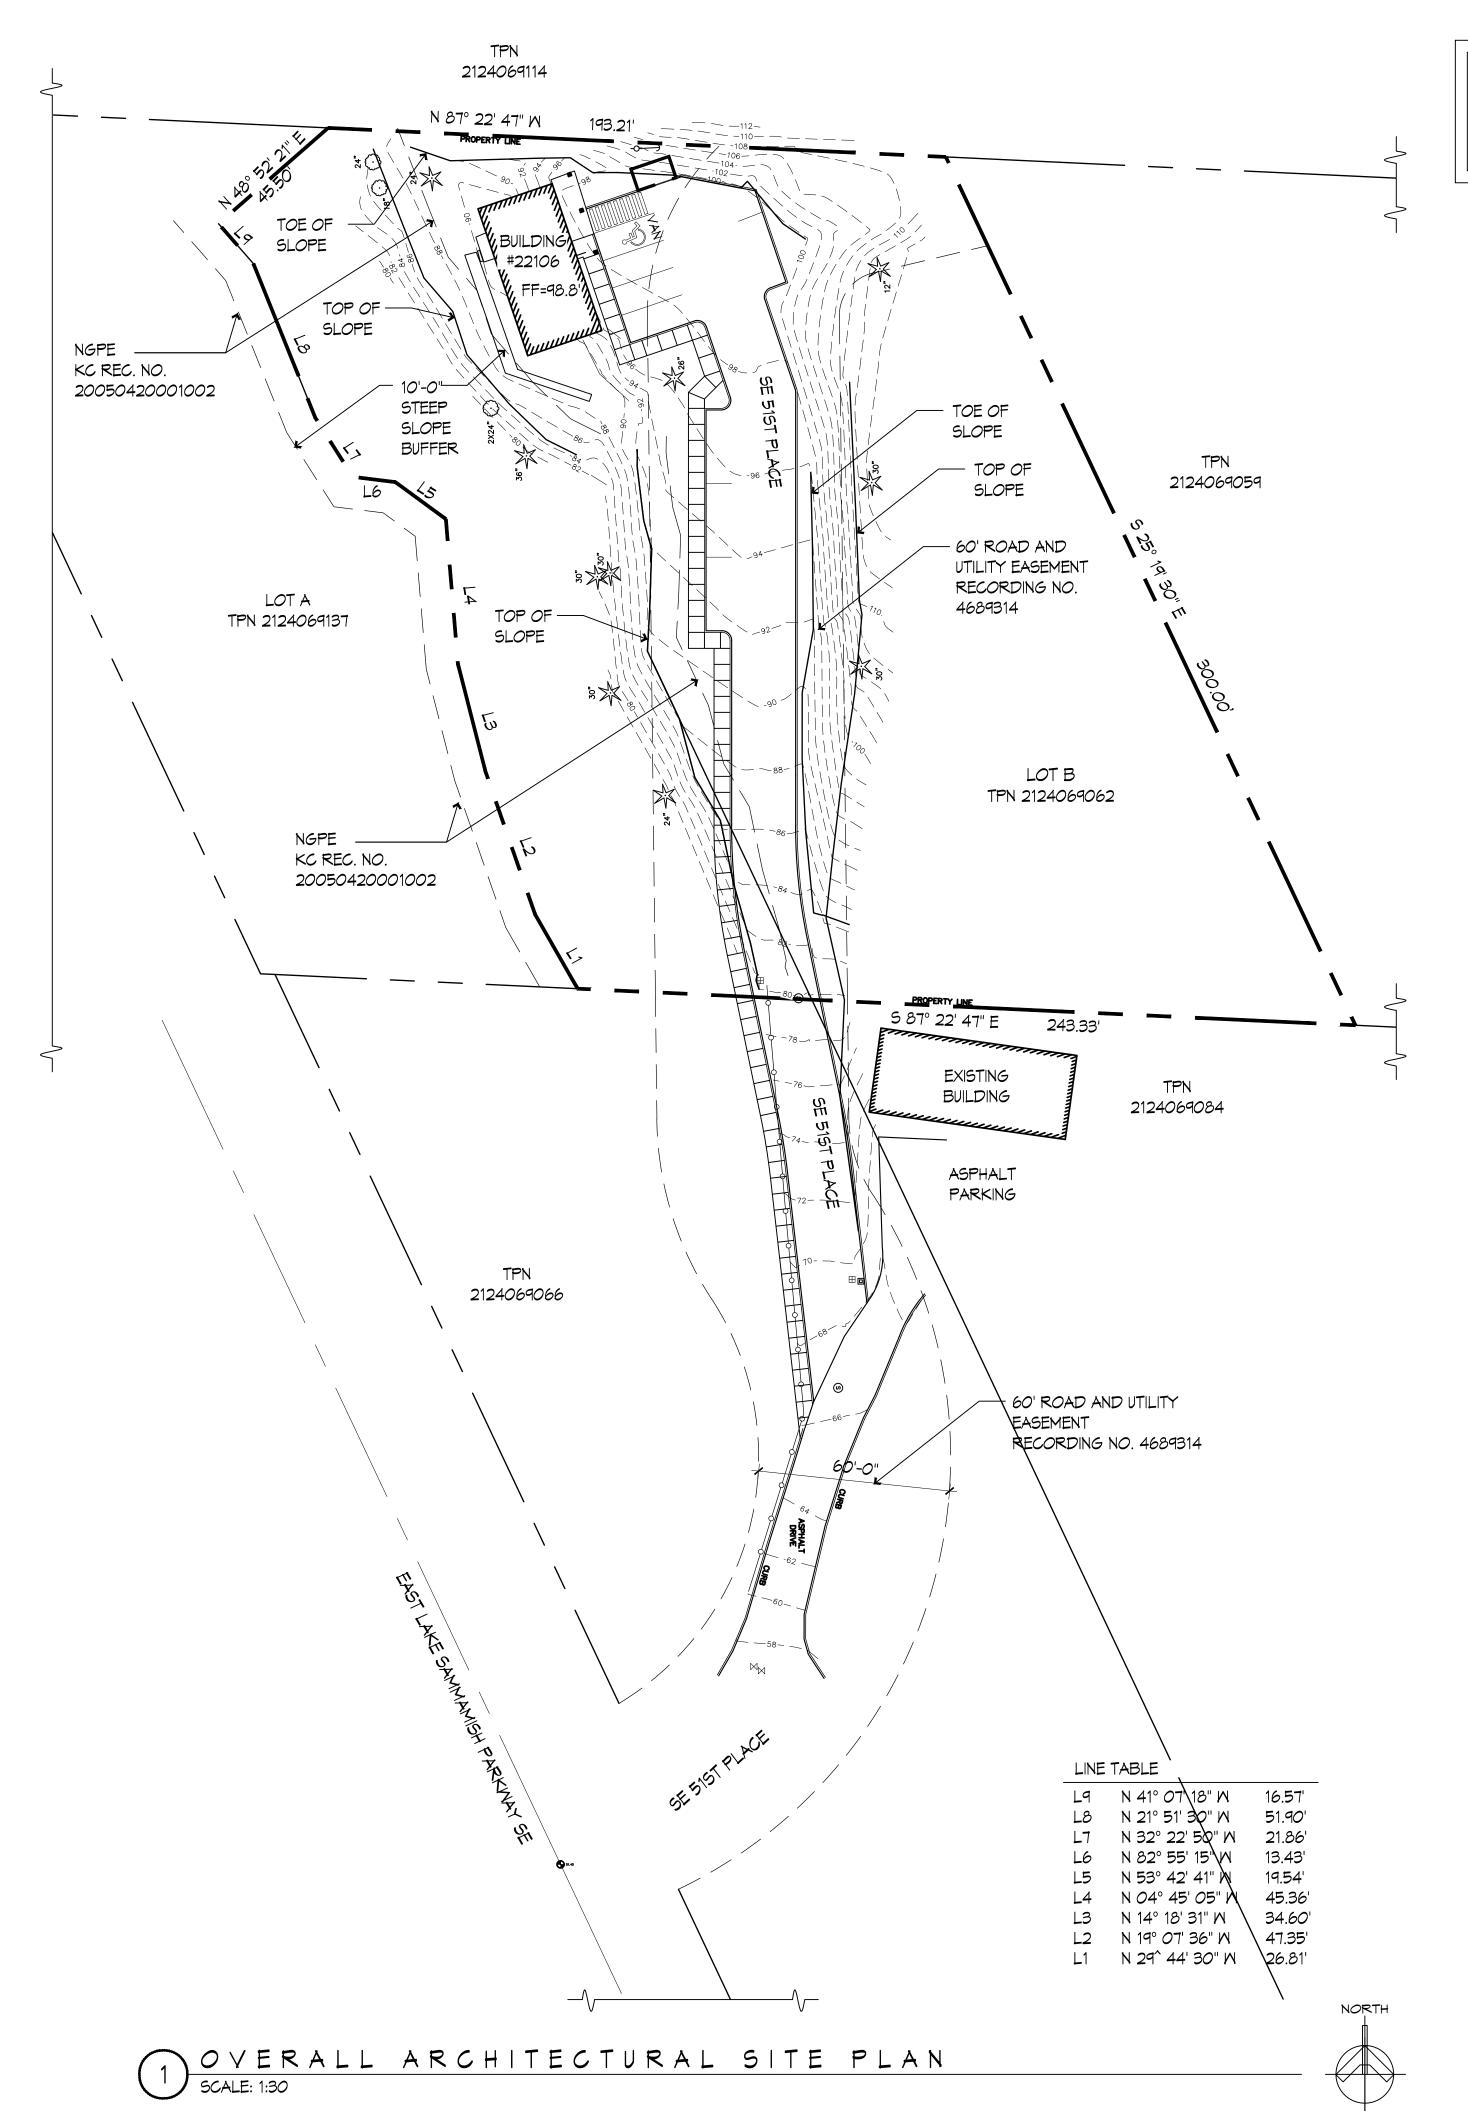

PRIOR TO BUILDING PERMIT ISSUANCE, A CRITICAL AREA TRACT (TO PROTECT THE STEEP SLOPE AND BUFFER) SHALL BE IN THE FORM OF A NATIVE GROWTH PROTECTION EASEMENT (NPGE) OR A DEED RESTRICTION ON THE PROPERTY TITLE OF THE PROJECT.

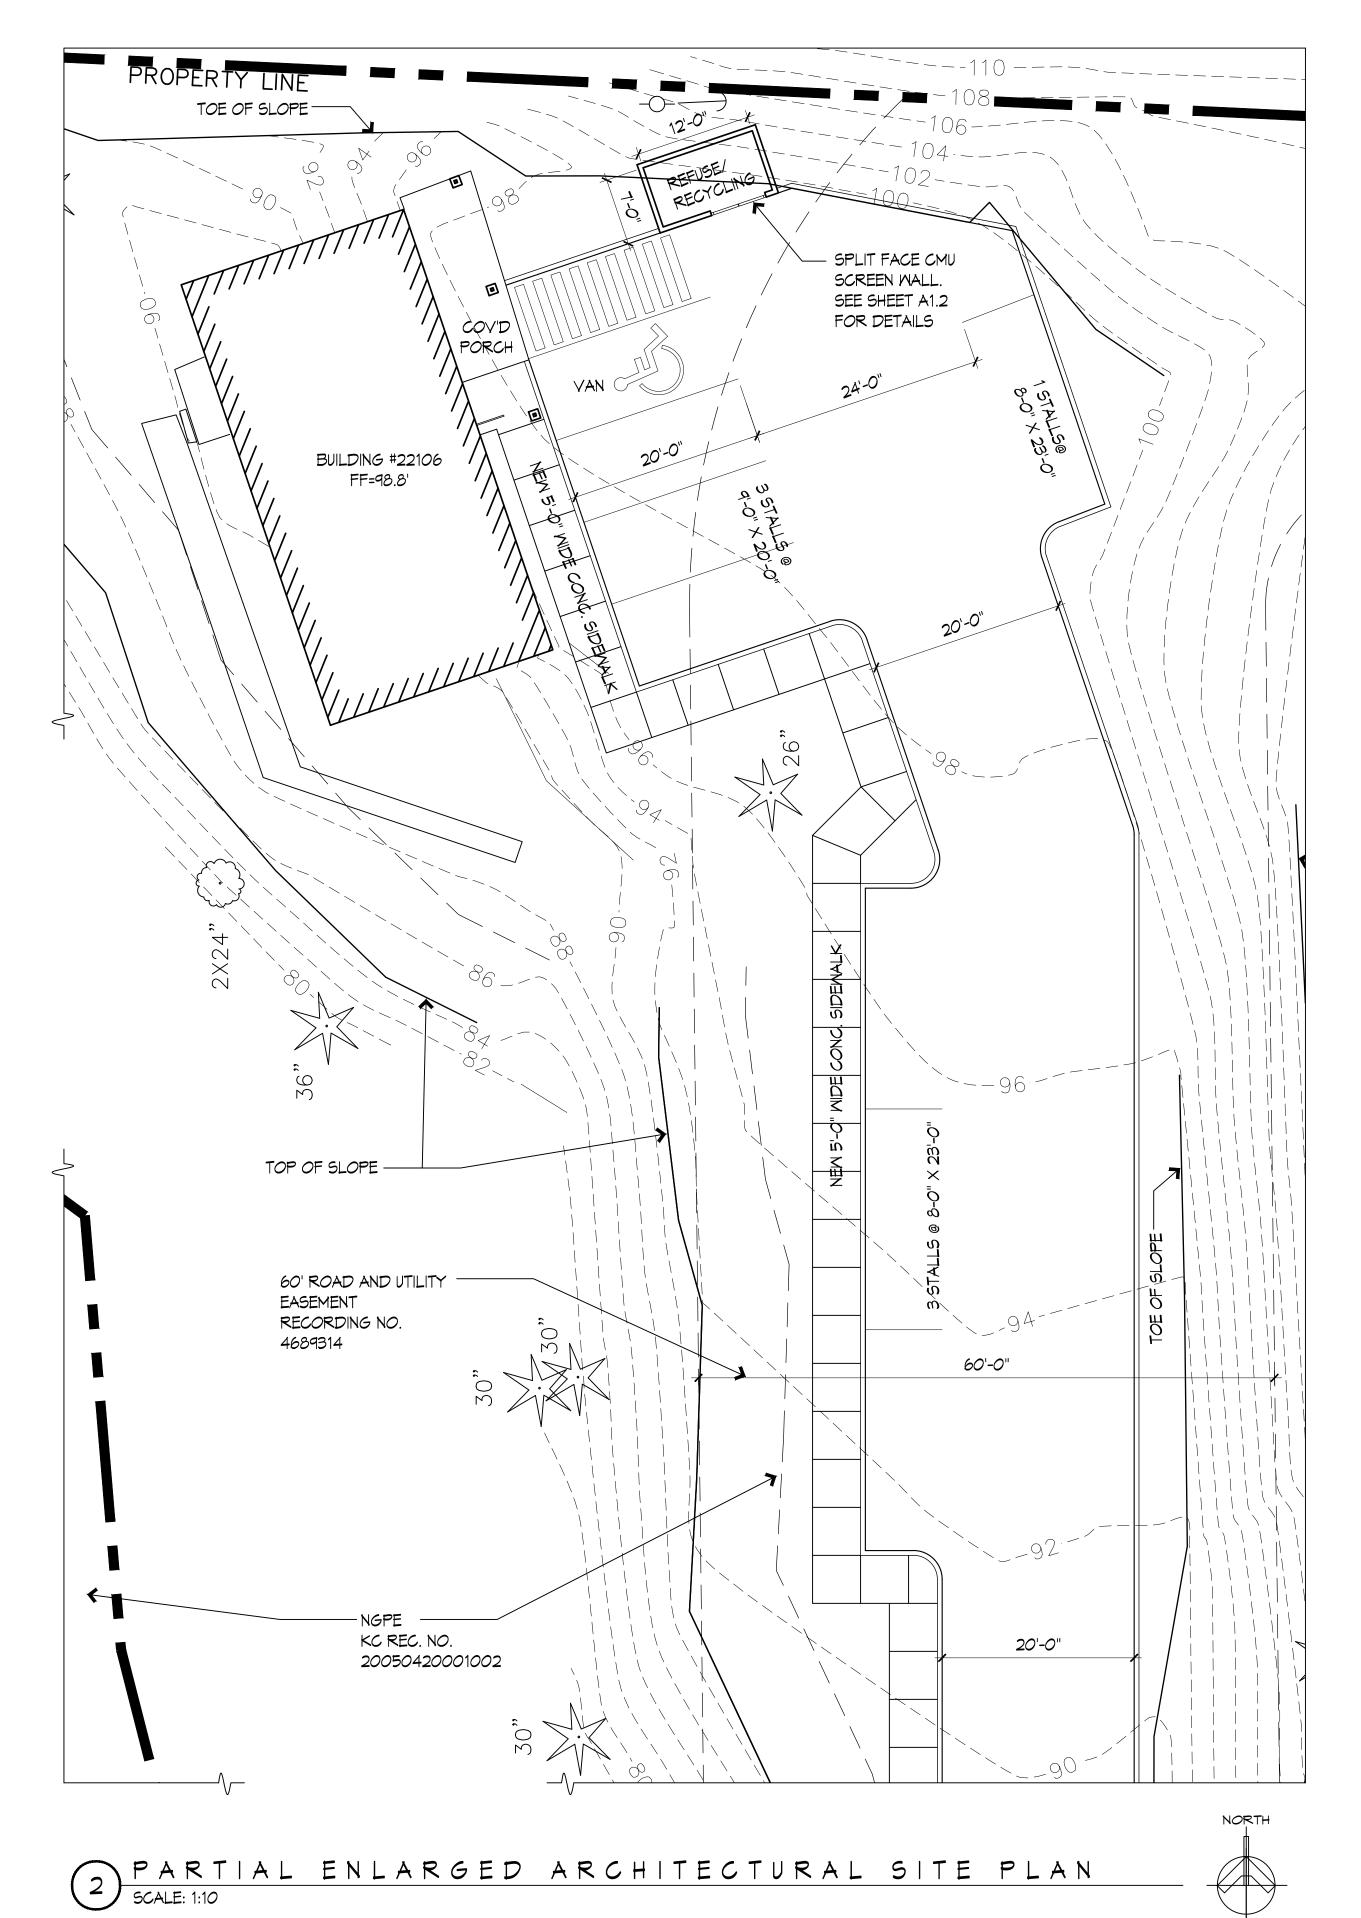

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⋖ □∷

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ASDP17-00005
22106 SE 51ST PLACE
ISSAQUAH, WA 98029

PERMIT SET

OVERALL ARCHITECTURAL SITE PLAN
PARTIAL ENLARGED ARCHITECTURAL SITE PLAN
REVISIONS


J. DATE IT


PROJECT NO: 18-007
DATE: 28 JUN 18

DRAWN BY: LPA
SHEET NO:

A1.0

A FIRE SPRINKLER SYSTEM AND FIRE ALARM SYSTEM SHALL BE INSTALLED PER NFPA 13 REQUIREMENTS DURING THE CHANGE OF USE PERMIT PROCESS.

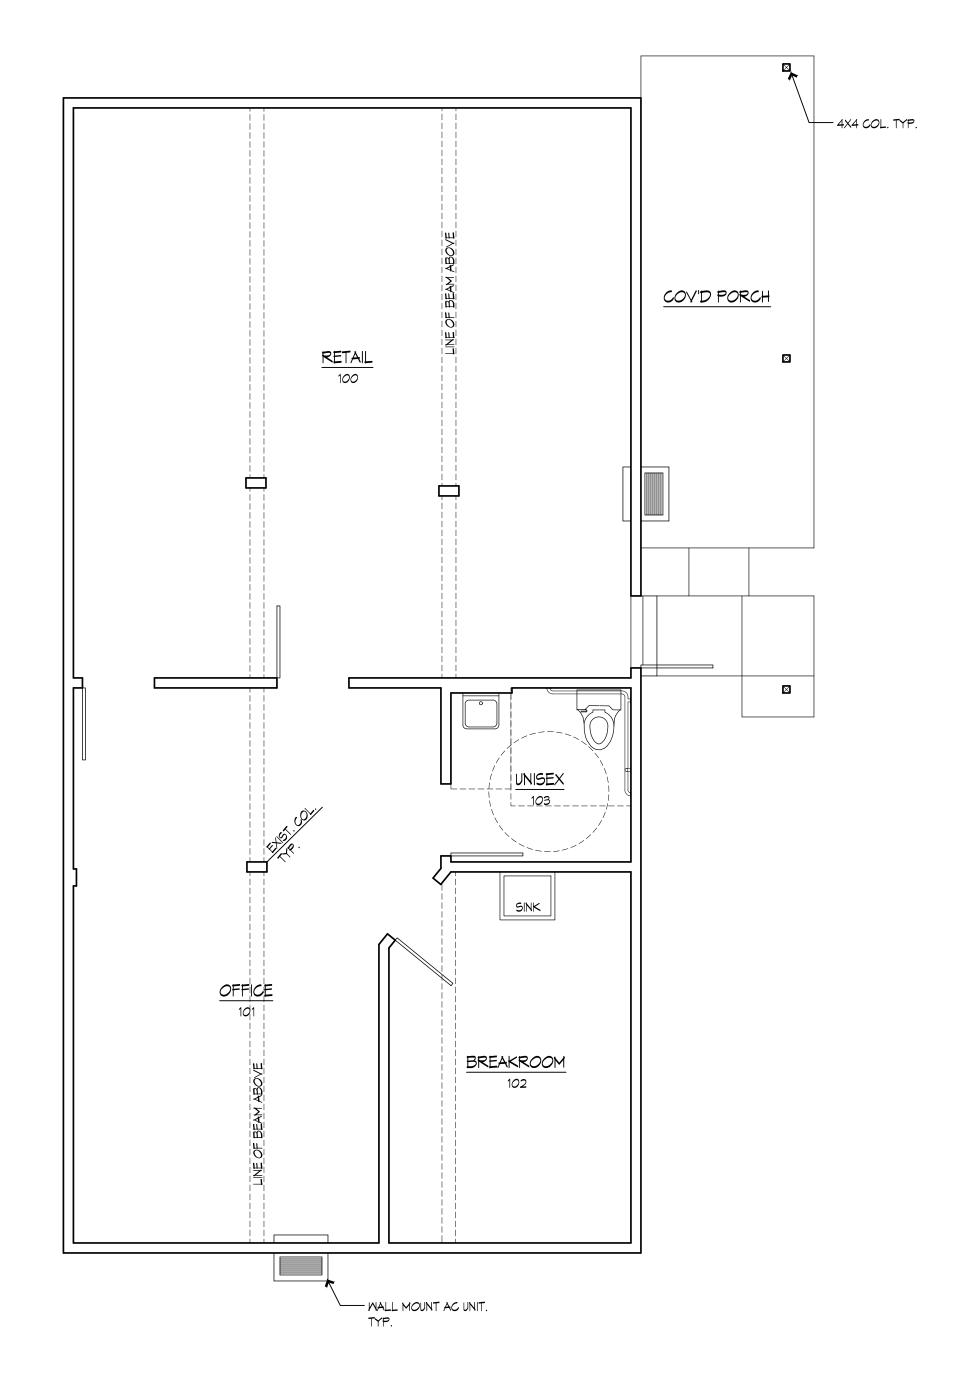

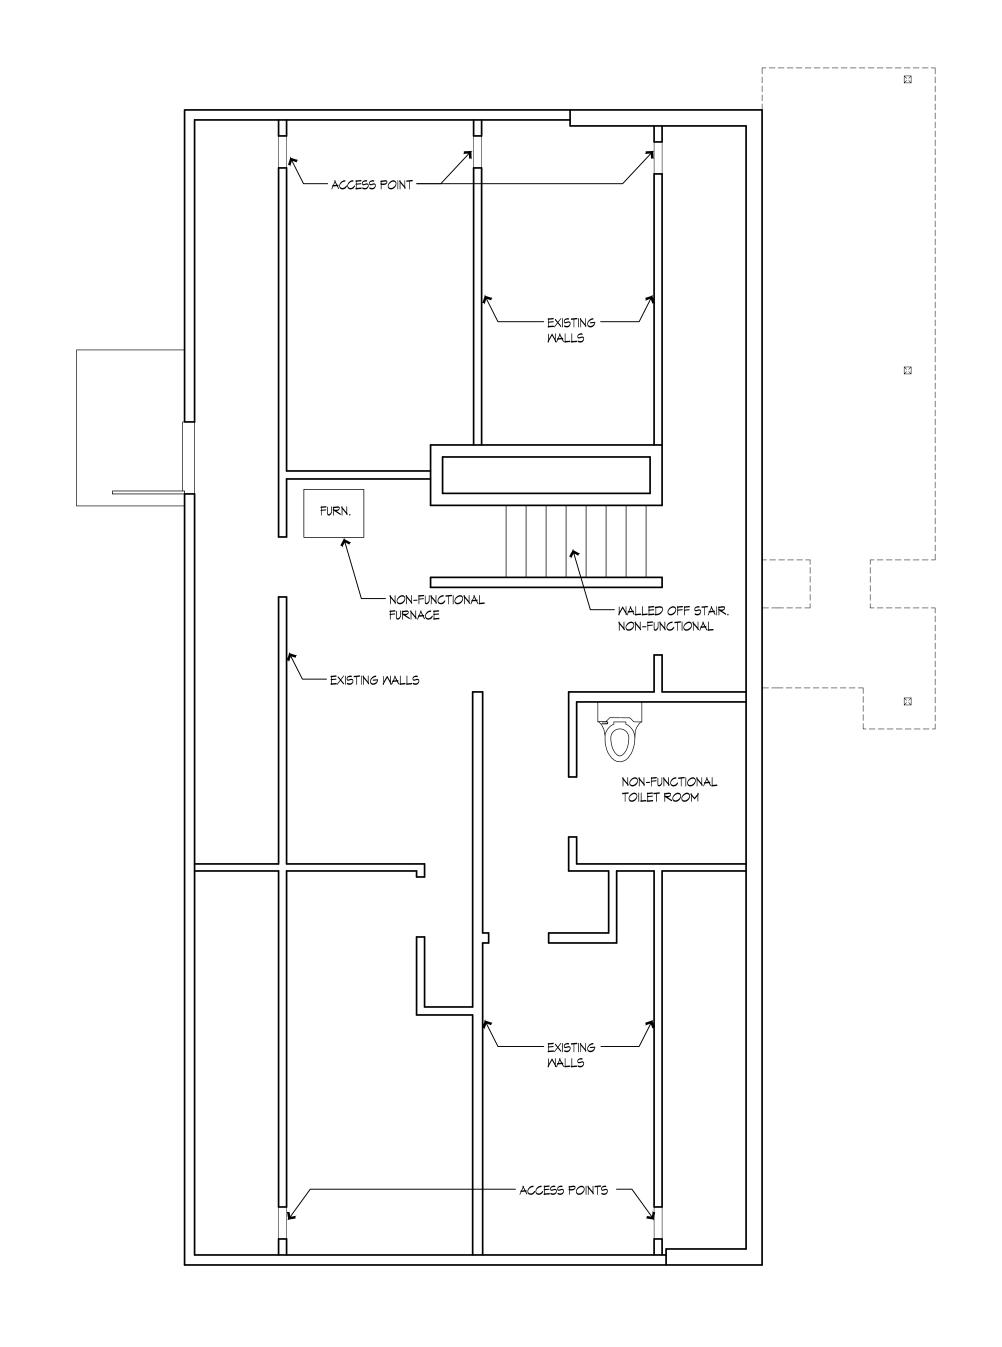

No. P. T.,

AS-BUILT BASEMENT FLOOR PLAN

SCALE: 1/4" = 1'-0"



ARCHITECTURE AND PLANNING TACOMA, WA 98403 P: 253.752.9409



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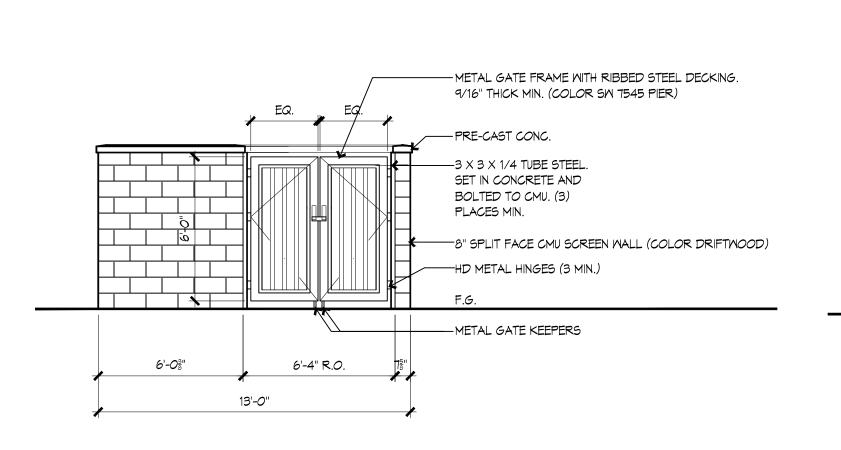
PERMIT SET


| CONT | ENTS |
|----------------------|-----------|
| AS-BUILT BASEMENT FL | LOOR PLAN |
| AS-BUILT MAIN FLOOR | PLAN |
| | |
| | |
| | |
| | |
| REVIS | SIONS |
| NO. DATE | ITEM |
| | |
| | |
| PROJECT NO: | 18-007 |
| DATE: | 28 JUN 18 |
| DRAWN BY: | LPA |
| SHEE | T NO: |

A1.1

2 AS-BUILT MAIN FLOOR PLAN

SCALE: 1/4" = 1'-0"




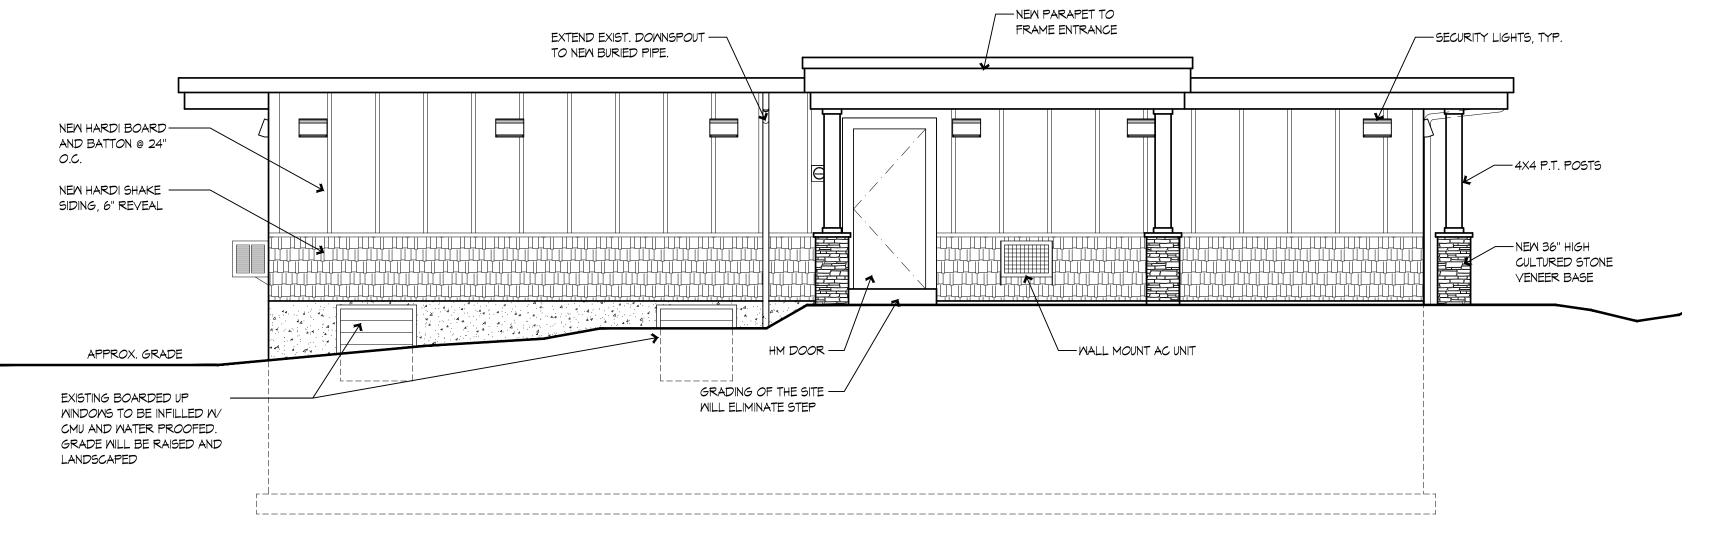


REFUSE/RECYCLING ENCLOSURE

SCALE: 1/4" = 1'-0"

1 EAST ELEVATION SCALE: 1/4" = 1'-0"

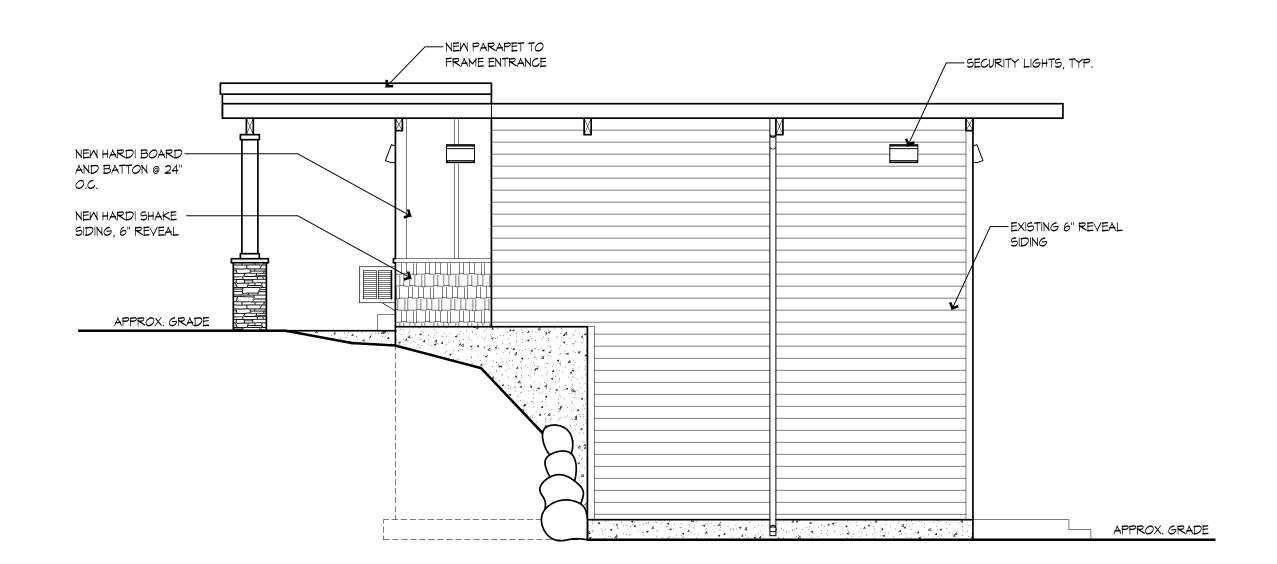


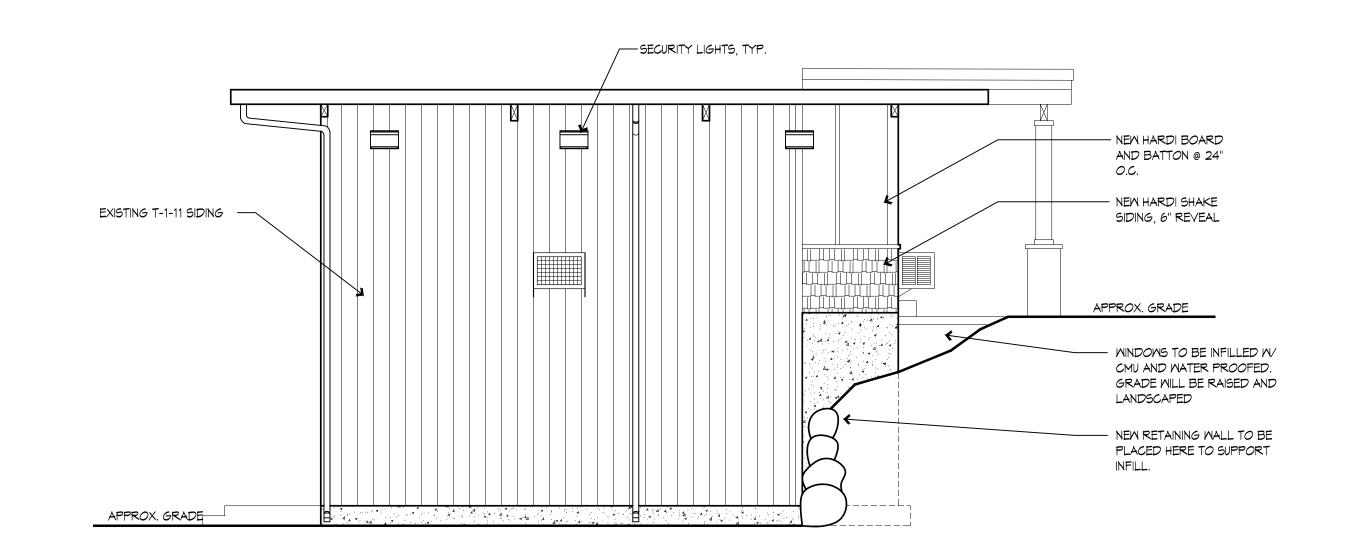

NORTH ELEVATION

SCALE: 1/4" = 1'-0"

3 SOUTH ELEVATION SCALE: 1/4" = 1'-0"

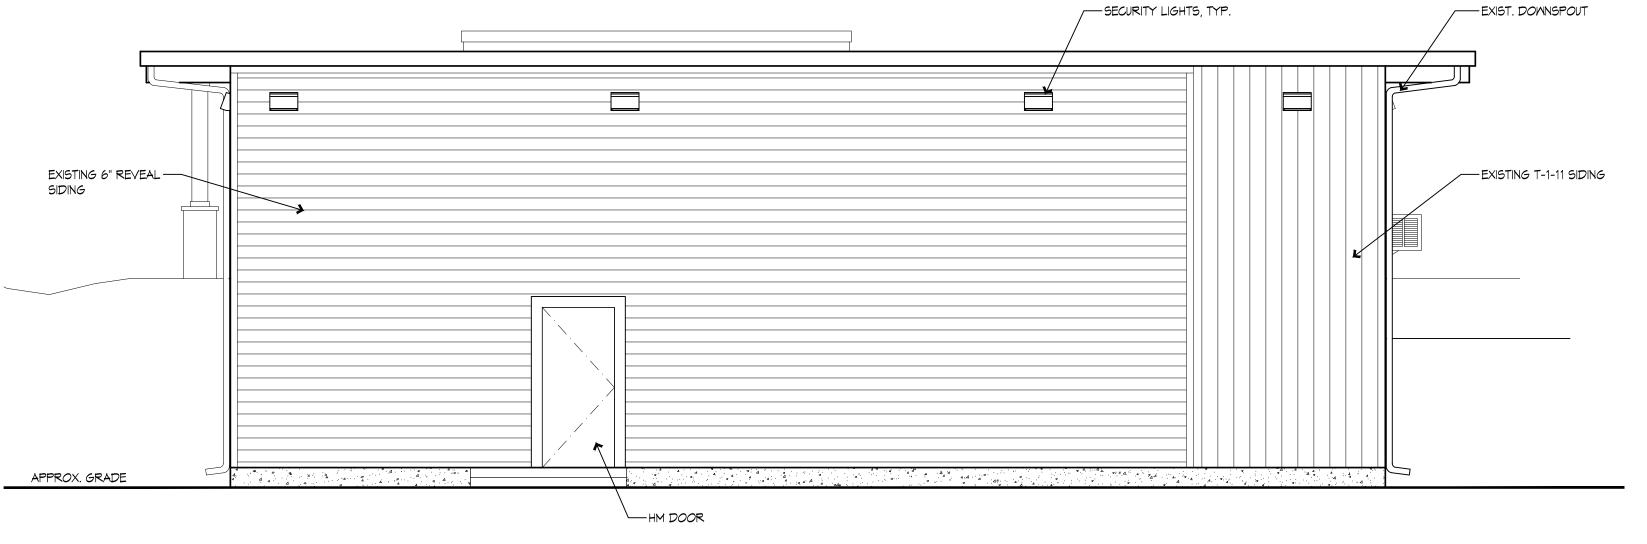

WEST ELEVATION

SCALE: 1/4" = 1'-0"

INSTALLED SECURITY LIGHTING:
RAB- SLIM 62Y 277VLED WALL PACK
SEE SPEC SHEET ATTACHED TO
COMMENT LETTER

ARCHITECTURE AND PLANNING

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F: 253.752.9409



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ASDP17-00005 22106 SE 51ST PLACE ISSAQUAH, WA 98029

PERMIT SET

ELEVATIONS
REFUSE ENCLOSURE DETAILS

REVISIONS

REVISIONS

NO. DATE ITEM

1 05 JUNE 18 DEPT. COMMENTS
2 28 JUNE 18 DEPT. COMMENTS
PROJECT NO: 18-007
DATE: 28 JUN 18
DRAWN BY: LPA

A1.2


SHEET NO:

MA

Design th Ave SE Bennis D 2105 36th Phone: 253

Issaquah Plan Grotto Green Gro SE 51st Place Landscape

22106

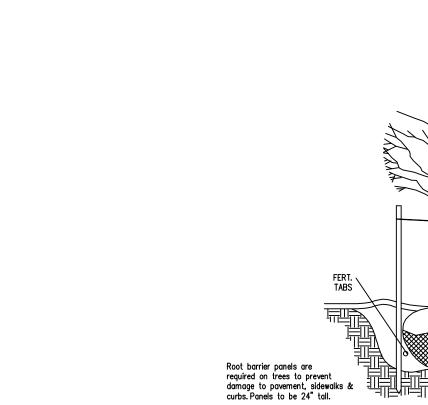




NURSERY.
PLACE AGRIFOM PLANT TABLETS ALONGSIDE THE ROOTBALL PER MANUFACTURER'S

AS SPECIFIED (2" MIN.)


REMOVE BURLAP FROM

MAKE SURE BOTTOM OF PLANT PIT IS WELL COMPACTED TO AVOID SETTLING

CUT WIRE BASKETS

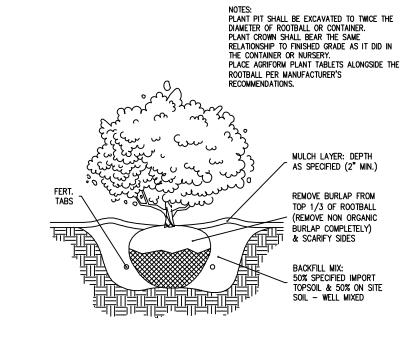



SHRUB PLANTING DETAIL SCALE: NTS

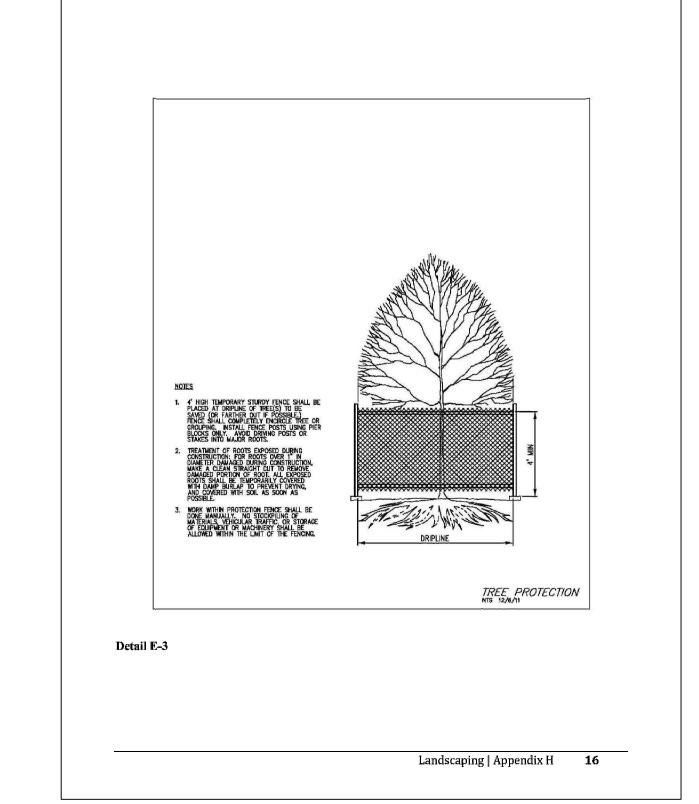

Landscape Notes:

- subgrade to be thoroughly tilled or scarified to a min. 12" depth
- 6" depth of 3 Way topsoil shall be installed in new planting beds and and incorporated to a depth of 12", if existing soil is determined to be . poor quality, sandy/rocky and little organic material.
- 3" depth of meduim grind dark bark mulch in new planting area
- installation of plant material per plan, installer to verify quantities.
- agriform, best, or equivalent plant tabs in planting pits
- planting / staking per details
- any clearing or grubbing by general contractor
- subgrades to be approved by landscape contractor
- prior to starting landscape work.
- provide one year written warranty for all plants
- all new plants will require temporary irrigation until established.
- plant material has been select to take advantage of similar soil and watering requirements. Little irrigation will be required for shrubs and ground cover are drought tolerant.

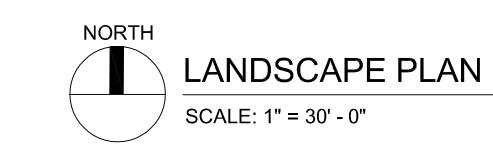

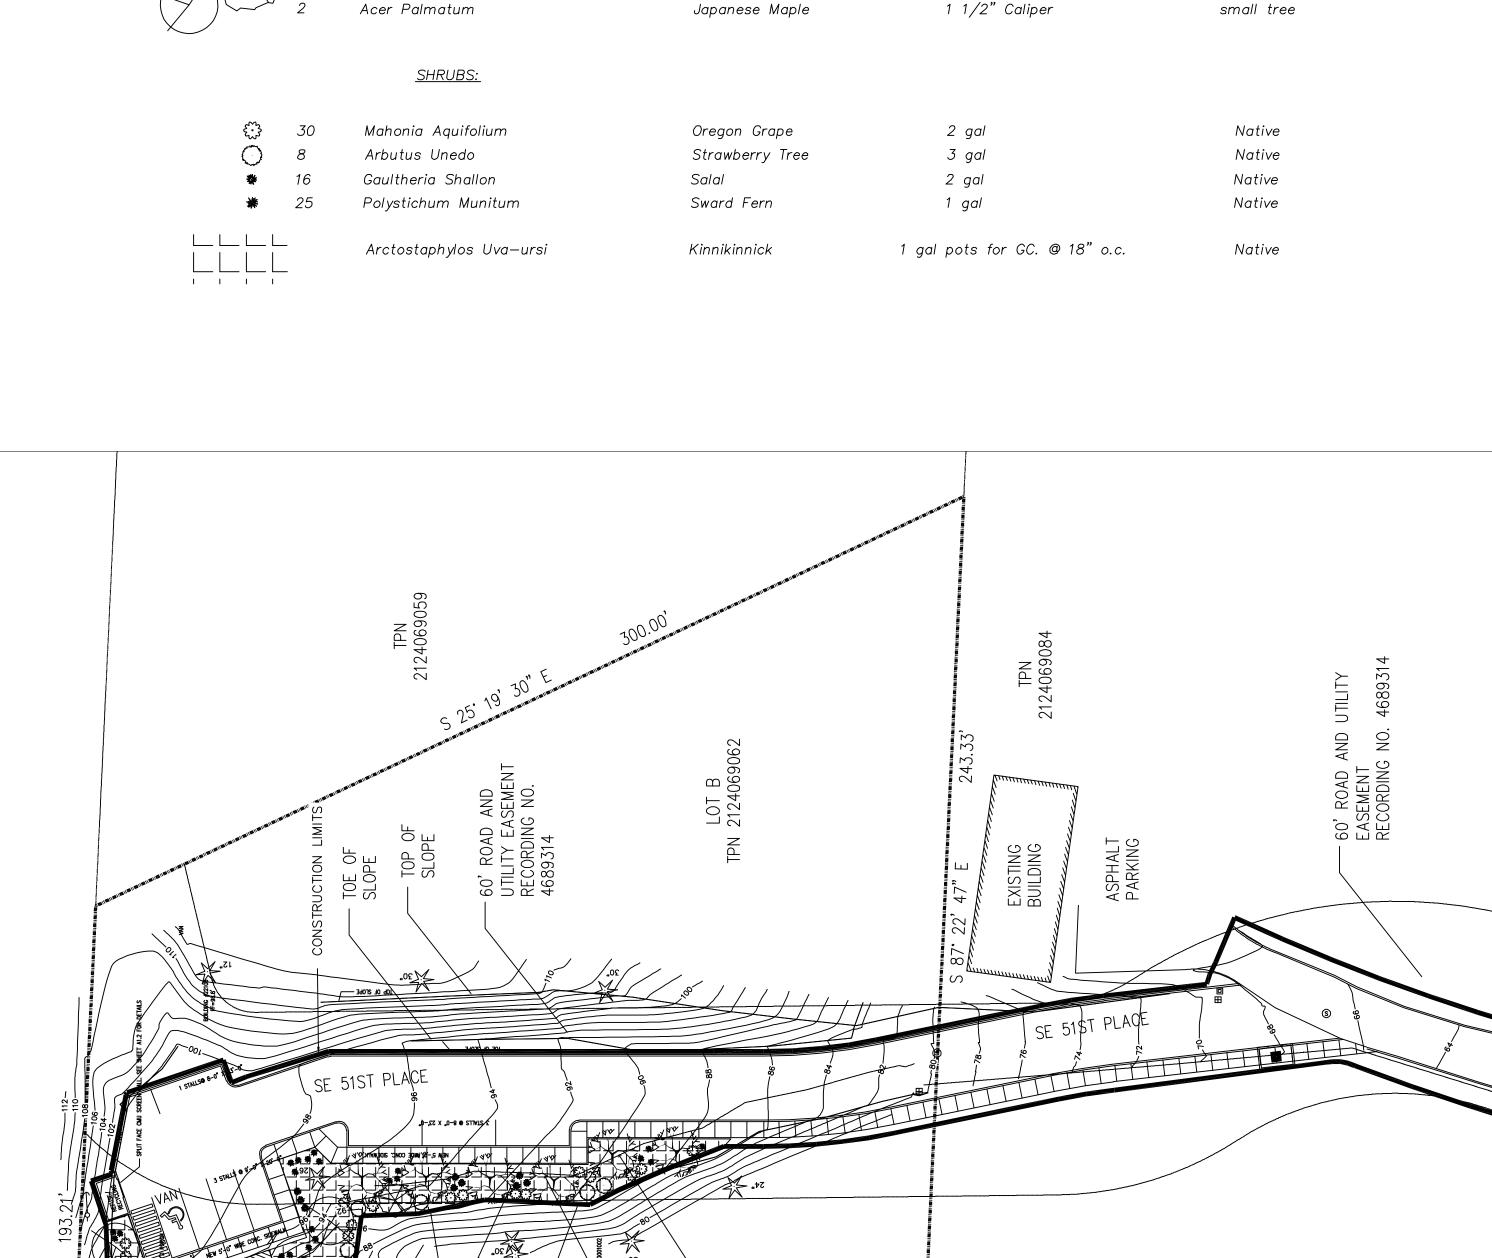

NGPE -KC REC.

<u>COMMON NAME</u>

Dwarf Hinoki Cypress

Eddie's White Wonder Dogwood 1 1/2" Caliper

PLANTING SIZE

6–8' ht

<u>COMMENTS</u>

medium tree

small tree/centennial tree

PLANT LIST

· 5 1 1 C

SCIENTIFIC NAME

TREES:

Cornus 'Eddie's White Wonder'

Chamaecyparis Obtusa 'Gracilis'

IRRIGATION MATERIALS LEGEND

DESCRIPTION

Rainbird XCZ100PRF Valves (1")

of building.

SYM.


| | Netafim Drip tubing, .4 gph, 18" o.c. spacing |
|--------|--|
| | |
| | Location not yet determined. |
| P.O.C. | Connect to waterline going into building. |
| | Sch 40 Mainline (1 1/4") — route shown for clarity |
| | Class 200 Lateral Lines & supply/exhaust header Class 200 Pipe Sizing: 0-10 GPM =3/4", 10-16 GPM =1", 16-26 GPM = 1 1/4", & 26-35 GPM = 1 1/2" |
| | |
| | Sch. 40 Sleeving (2 X pipe(s) passing through sleeve) |
| | Quick Coupler Valve Rainbird 33DRC |
| | Gate Valve Watts 1 1/2" |


Rainbird ESP LX modular controller to be located on outside

IRRIGATION NOTES

- plan is diagrammatic in nature adjustments will be required to ensure full coverage of all designated areas to receive irrigation
- Drip layout typical and per Netafim specs
- Drip supply header to be 3/4" class 200 pvc.
- system designed is based upon 50 PSI at POC.
- refer to material legend for actual part descriptions
- sleeve under all hardscape whether or not noted on plan (2 X interior pipe(s) passing through sleeve)
- sleeves shall be installed at a depth of 24" (top of pipe typ.)
- (plate compact sleeve trenches to avoid settling)
- mainline shall be installed at a depth of 18" (top of pipe)
- laterals shall be installed at a depth of 12" (top of pipe)
- all pipe to be installed with factory printing facing up (to facilitate any future pipe repairs or extensions)
- utilize select backfill in trenches (no rocks adjacent to pipe)
- all wire splices shall be made with "dry—splices" and be located
- in junction boxes (unless at valve) — contractor shall include initial system winterization and start—up
- provide accurate "as-built" drawing to owner and landscape representative (mount reduced sized drawing (laminated) next to controller for easy
- reference by maintenance staff)

 verify all utility locations prior to commencing work - CALL BEFORE YOU DIG # 1-800-555-4444
- irrigation contractor will determine pipe sizing
- some irrigation piping is shown outside landscape beds for clarity all piping is to be located within landscape areas w/ exception to pipes in sleeves

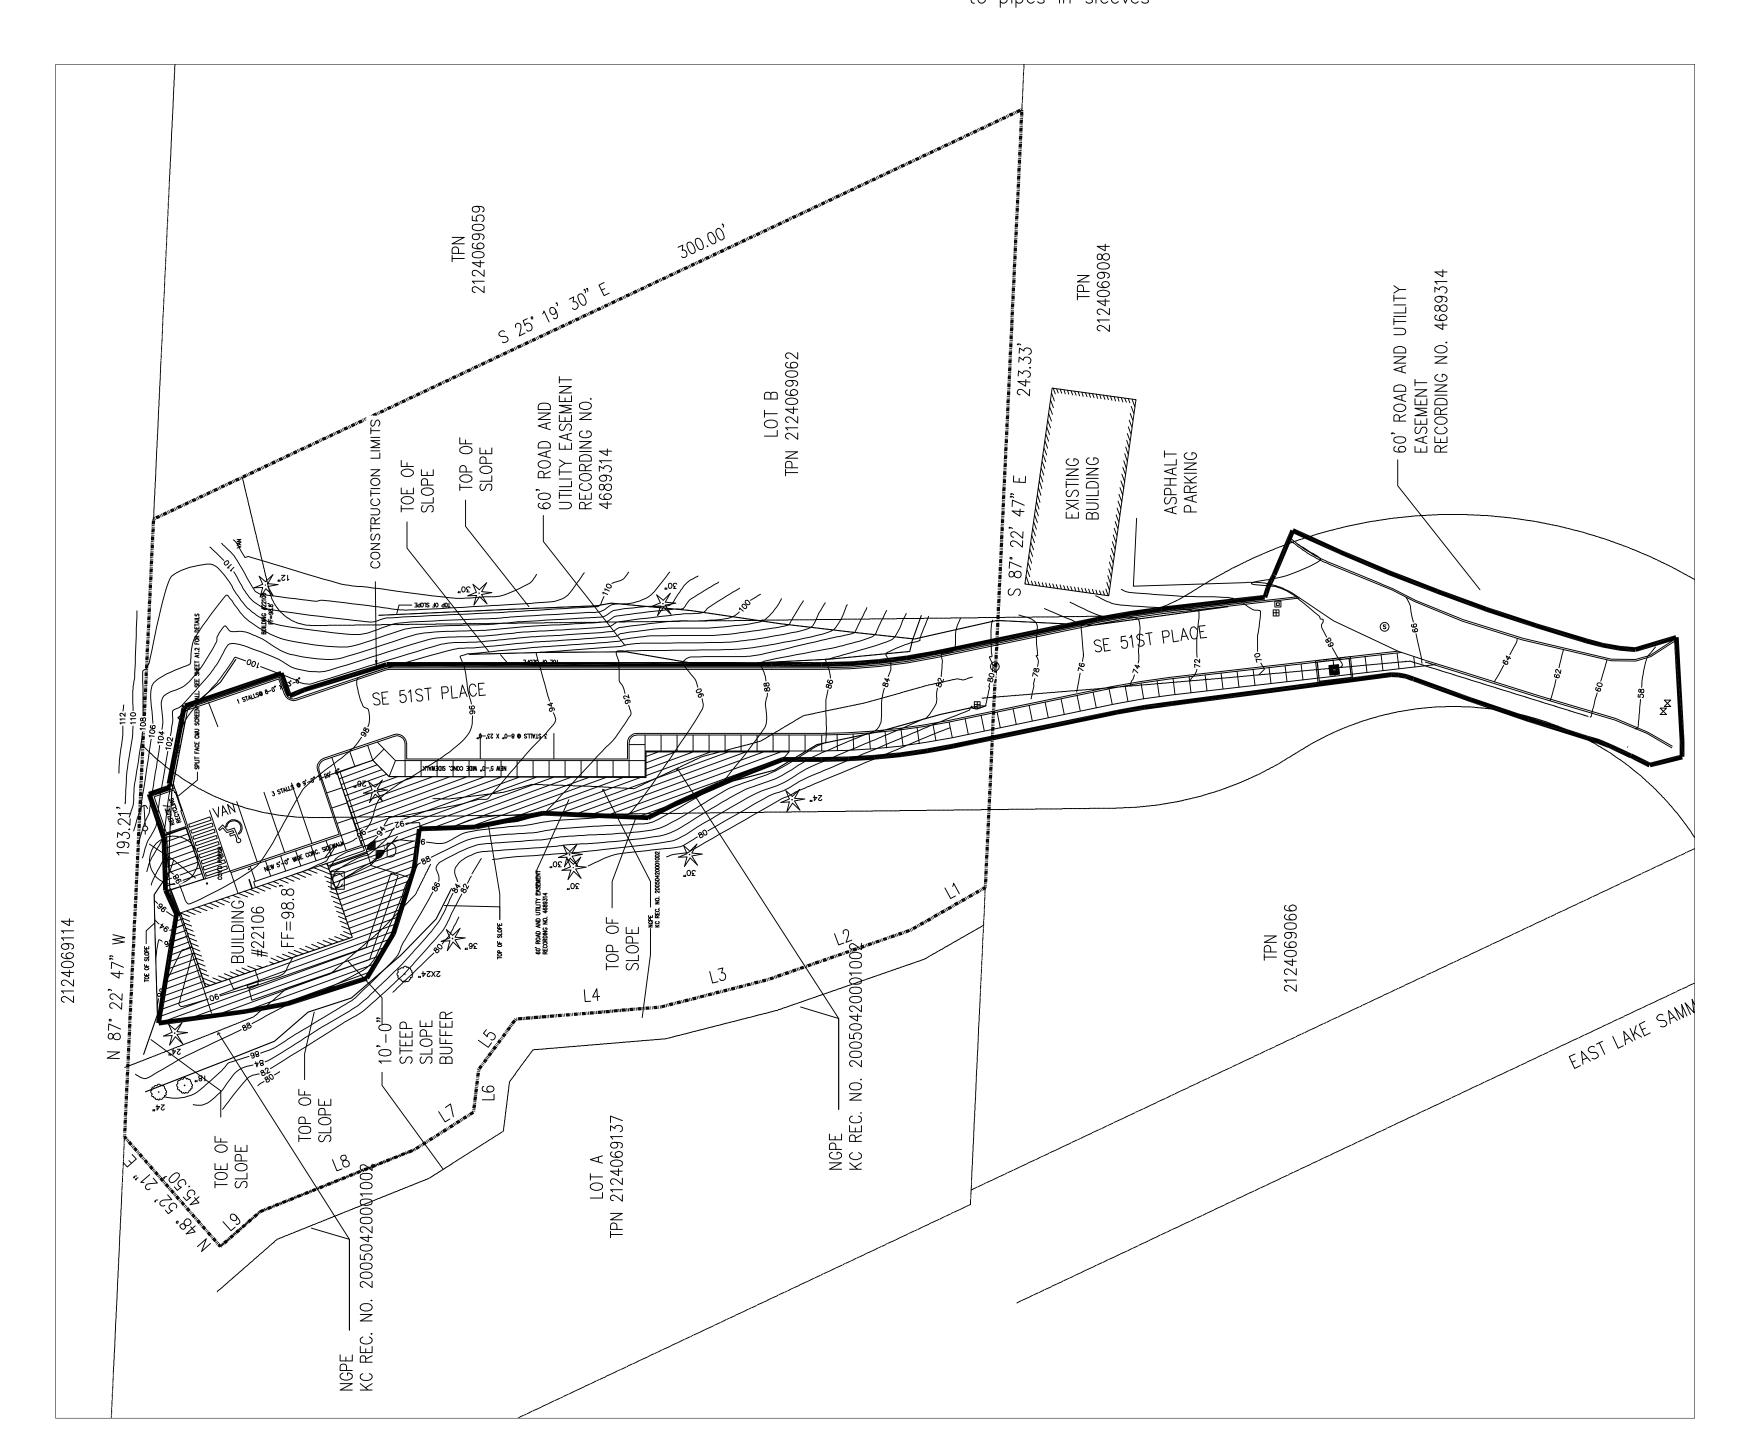

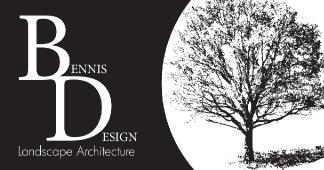





Christopher Paul Bennis CERTIFICATE NO. 973

MADesign th Ave SE Puyallup, 53-350-5844

Bennis D. 2105 36th Phone: 253-

MAGreen Grotto SE 51st Place Issaqı Irrigation Plan Issaq Plan 22106

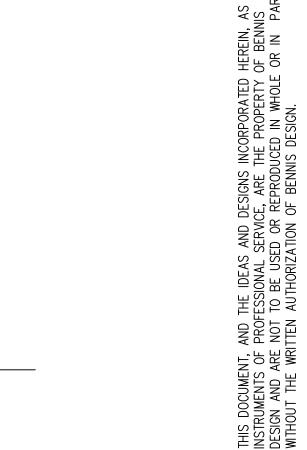

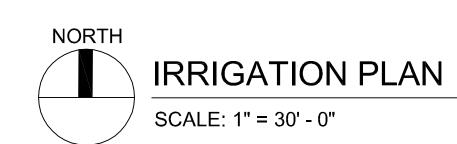


MADesign th Ave SE Puyallup, 53—350—5844 Bennis D 2105 36th Phone:253-

Green Grotto 22106 SE 51st Place Issaquah, V Irrigation Details Plan

| Foldiv. | S SHALL VERIFY ALL ND ANY OMISSIONS OR R REPRESENTATIVE. | Not to scale | Revised: | |
|-------------------------------|--|--------------|-----------|--|
| INUNIZATION OF BENNIS DESIGN. | BE SCALED. CONTRACTORS SHALL VERIFY ALL AMENCEMENT OF WORK, AND ANY OMISSIONS OR REPORTED TO THE OWNER REPRESENTATIVE. | esign: CPB | rawn: CPB | |

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| <u>-</u> | | A C C C + +C N |

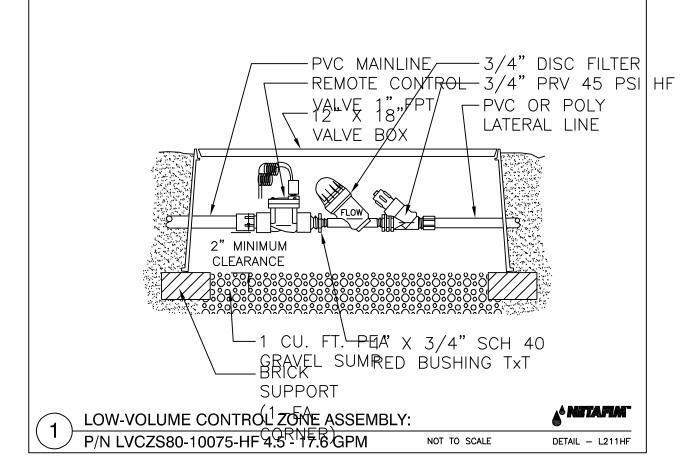

FINISH GRADE -

SPECS

— PVC LATERAL OR EXHAUST HEADER

— PVC REDUCER ADAPTER S X 1/2" FPT (SIZE AS REQUIRED)

& NETAFIM"

DETAIL - D222T

A RETAFIN

DETAIL - D273

LINE FLUSHING — VALVE #TL050MFV—1

3/4" GRAVEL SUMP -(1 CUBIC FOOT)

FINISH GRADE —

AIR/VACUUM -RELIEF VALVE

6" ROUND — VALVE BOX

1/2" PVC COUPLING — (TxT)

1/2" SCH 80 RISER —— (LENGTH AS REQUIRED)

3/4" GRAVEL SUMP — (1 CUBIC FOOT)


NOT TO SCALE


Techline® LINE FLUSHING VALVE (PLUMBED TO PVC)


NOT TO SCALE


Techline® AIR/VACUUM RELIEF (PLUMBED TO PVC)

NOT TO SCALE

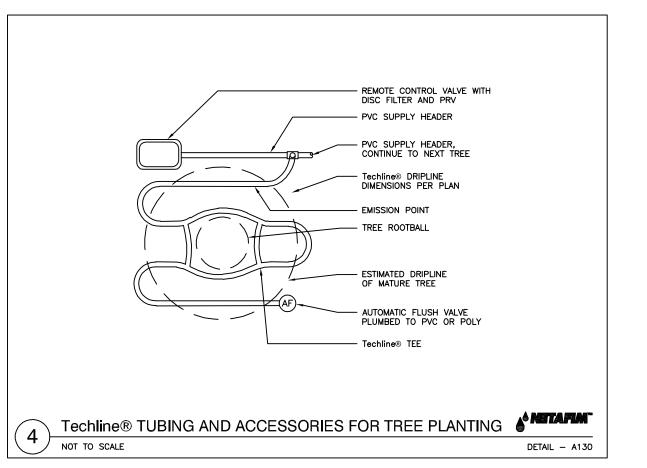

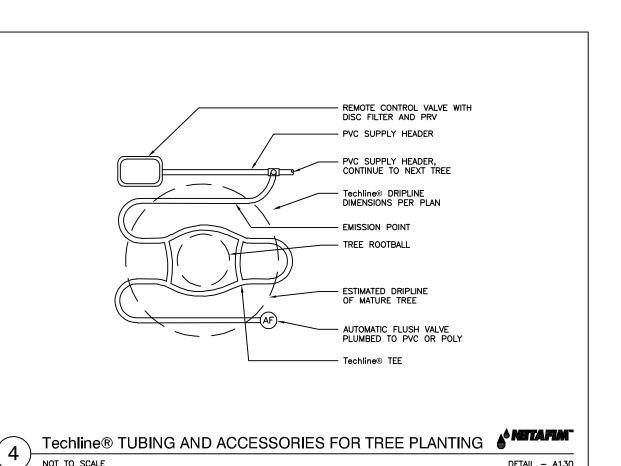

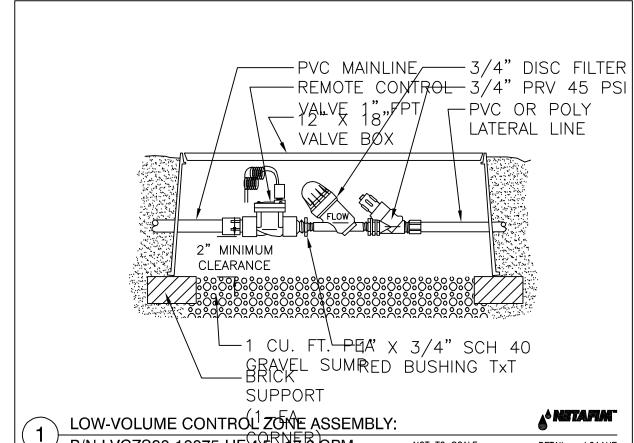

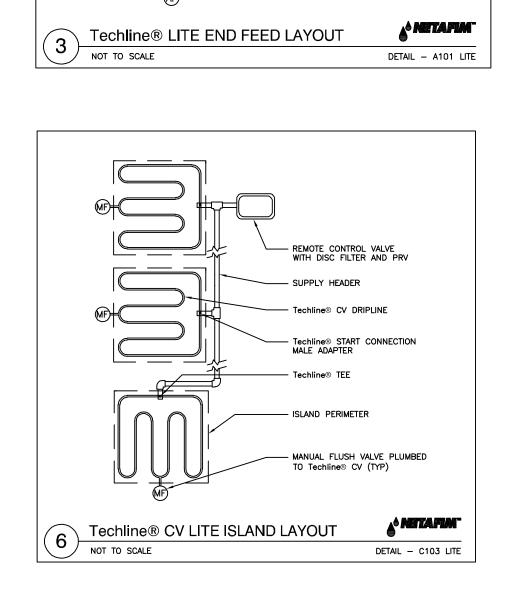

FINISH GRADE

LATERAL LINE

MAINLINE PIPING -

TRENCH

SCALE:

→ CLEAN MATERIAL FREE OF DEBRIS LARGER THAN 2" FOR TRENCH BACKFILL

─14 GA. CONTROL WIRE TAPED TOGETHER AT 10'O.C. LOCATE 6" MIN. FROM SIDE OF MAINLINE.

- REMOTE CONTROL VALVE WITH DISC FILTER AND PRV

- Techline® START CONNECTION MALE ADAPTER AND TEE

— AREA PERIMETER

FOR ROW SPACING

— PERIMETER LATERALS 2" TO 4" FROM EDGE

— Techline® DRIPLINE

- AUTOMATIC FLUSH VALVE PLUMBED TO Techline®